BOTSFORD / BUDRECKIS RESIDENCE SANTA BARBARA, CA

F.A.R. Calculator

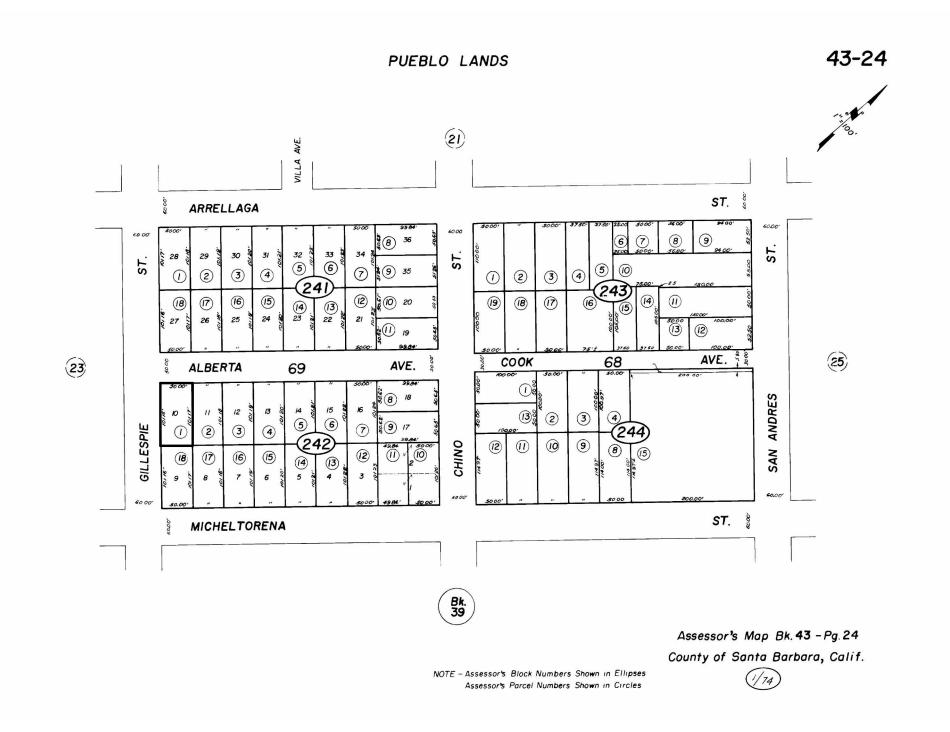
Instructions: Enter the information in the white boxes below. The spreadsheet will calculate the proposed FAR (floor area ratio), the 100% max FAR (per the Zoning Ordinance for "Required FAR"), and the 85% max FAR (per the Zoning Ordinance for "Required FAR"). Additionally it will determine whether a FAR Modification is required. "Guideline FAR" calculations are as outlined in the "Applicability" section of the Single Family Residence Design Guidelines, page 23-C.

The Net Lot Area does not include any Public Road Easements or Public Road Right-of-Way areas. The proposed TOTAL Net FAR Floor Area shall include the net floor area of all stories of all building, but may or may not include basement/cellar floor area. For further clarification on these definitions please refer to SBMC §28.15.083 & 30.300. This form has not yet been updated for current Title 30 zone designations,

ENTER Project Address:	835 Alberta Ave	
there a basement or cellar existing or proposed?	No	
ENTER Proposed TOTAL Net FAR Floor Area (in sq. ft.):	1,856	
ENTER Zone ONLY from drop-down list:	R-2	
ENTER Net Lot Area (in sq. ft.):	5,000	
Is the height of existing or proposed buildings 17 feet or greater?	Yes	
Are existing or proposed buildings two stories or greater?	Yes	
The FAR Requirements are:	GUIDELINE**	
ENTER Average Slope of Lot:	5.00%	
Does the height of existing or proposed buildings exceed 25 feet?	No	
Is the site in the Hillside Design District?	No	
Does the project include 500 or more cu. yds. of grading outside the main building footprint?	No	
An FAR MOD is not required per SBM	MC §28.15 or §30.20.030	
FLOOR AREA RATIO (FAR):	0.371	
Lot Size Range:	4,000 - 9,999 sq.ft.	
MAX FAR Calculation (in sq. ft.):	1,200 + (0.25 x lot size in sq.ft.)	
100% MAX FAR:	0.490	
100% MAX FAR (in sq. ft.):	2,450	
85% of MAX FAR (in sq. ft.):	2,083	
80% of MAX FAR (in sq. ft.):	1,960	

* NOTE: Percentage total is rounded up. **NOTE: If your project is located on a site with multiple or overlay zones, please contact Planning Staff to confirm whether the FAR

Acreage Conversion Calculator				
ENTER Acreage to Convert to square footage:	1.00			
Net Lot Area (in sq. ft.):	43560			



LOWER FLOOR DEMO PLAN A1.1E EXISTING LOWER FLOOR PLAN A1.1P PROPOSED LOWER FLOOR PLAN PROPOSED UPPER FLOOR PLAN A2.1E EXISTING EXTERIOR ELEVATIONS PROPOSED EXTERIOR ELEVATIONS ARCHITECTURAL DETAILS WINDOW AND DOOR SCHEDULES AND

EXISTING AND PROPOSED SITE PLAN

INDEX OF DRAWINGS

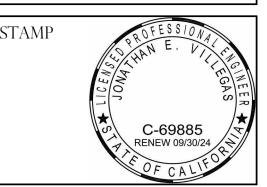
A7.1 3D VIEWS

SHEET INDEX

PROJECT INFORMATION SHEET

SHEET NAME

SANTA YNEZ, CA 93460 805.680.6874 (OFFICE) 805.456.3854 (FAX) DARKMOONENG@GMAIL.COM WWW.DARKMOONENGINEERING.COM



Drawing Notes: The use of these plans and specifications shall be restricted to the original site for which they were prepared and publication thereof is expressly limited to such use. Reproduction or publication by any method, in whole or in part, is prohibited. Titl evidence of the acceptance of these restrictions. DO NOT SCALE THESE DRAWINGS. See Architectural plans for written dimensions. dimensions and existing conditions on the job and shall report resolution prior to commencing with the work in question

to these plans and specifications remain with Darkmoon Building Design and Engineering without prejudice. Visual contact with these plans and specifications shall constitute prima facie

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PROJECT DESCRIPTION

PROPOSED NEW 1ST FLOOR AREA (141 SF) PROPOSED NEW 2ND FLOOR AREA (629 SF)

SCOPE OF WORK

PROPOSED NEW 2ND FLOOR DECK AT MASTER (106 SF)

PROPOSED NEW 2ND FLOOR DECK AT MULTI PURPOSÉ ROOM (45 SF) DEMOLISH A PORTION OF EXISTING ROOF FOR 2ND FLOOR ADDITION INTERIOR REMODEL KITCHEN, BEDROOMS AND BATH

> YEAR BUILT: CONSTRUCTION TYPE: ZONING DESIGNATION: OCCUPANCY GROUP: NUMBER OF STORIES: **BUILDING HEIGHTS EXISTING RESIDENCE:** PROPOSED 2nd STORY PARCEL SIZE: AVERAGE LOT SLOPE: HIGH FIRE: FLOOD PLAIN:

FLOOR AREA CALCULATIONS **EXISTING FLOOR AREA** (E) 1 STORY RESIDENCE:

TOTAL (E) FLOOR AREA: PROPOSED FLOOR AREA TOTAL (P) FLOOR AREA:

770 SF NET / 833 SF GROSS

ALL AMENDMENTS AS ADOPTED IN THE SANTA BARBARA CITY ORDINANCE 5919 AND ALL OTHER CODES, REGULATIONS, AND APPROVALS ESTABLISHED BY THE CITY OF SANTA BARBARA

THIS PROJECTS INTENT IS TO COMPLY WITH THE FOLLOWING CODES

CALIFORNIA BUILDING CODE [CBC] 2022
CALIFORNIA MECHANICAL CODE [CMC] 2022
CALIFORNIA ELECTRICAL CODE [CEC] 2022
CALIFORNIA PLUMBING CODE [CPC] 2022
CALIFORNIA RESIDENTIAL CODE [CRC] 2022
CALIFORNIA GREEN STANDARDS BUILDING CODE [CGSBC] 2022
CALIFORNIA ENERGY CODE 2022
CALIFORNIA FIRE CODE 2022

SPECIAL INSPECTIONS AND OBSERVATIONS

SEE SHEET S0.1 FOR STRUCTURAL SPECIAL INSPECTIONS **OBSERVATIONS REQUIRED**

CODE COMPLIANCE

AND ORDINANCES:

DAINA BUDRECKIS AND DAVID BOTSFORD OWNERS: PROJECT LOCATION: SANTA BARBARA, CA 93101 ACCESSORS PARCEL NUMBER: 043-242-001 TYPE V - NON RATED 1 EXISTING / 2 PROPOSED 16'-10" TO RIDGE 24'-11 1/2" TO RIDGE 5,000 SF (0.11 ACRES)

(E) DETACHED 1-CAR GARAGE: 181 SF NET / 202 SF GROSS 1086 SF NET / 1165 SF GROSS (N) 1 STORY RESIDENCE ADDITION: 141 SF NET / 162 SF GROSS (N) 2 STORY RESIDENCE ADDITION: 629 SF NET / 671 SF GROSS

TOTAL PROPOSED FLOOR AREA 1856 SF NET / 1998 SF GROSS (EXISTING - DEMOLITION + ADDITIONS = TOTAL PROPOSED)

(N) 2ND STORY DECK AT MASTER: (N) 2ND STORY DECK AT MULTI PURPOSE ROOM: PROPOSED GRADING 0 CY 0 CY NET (CUT):

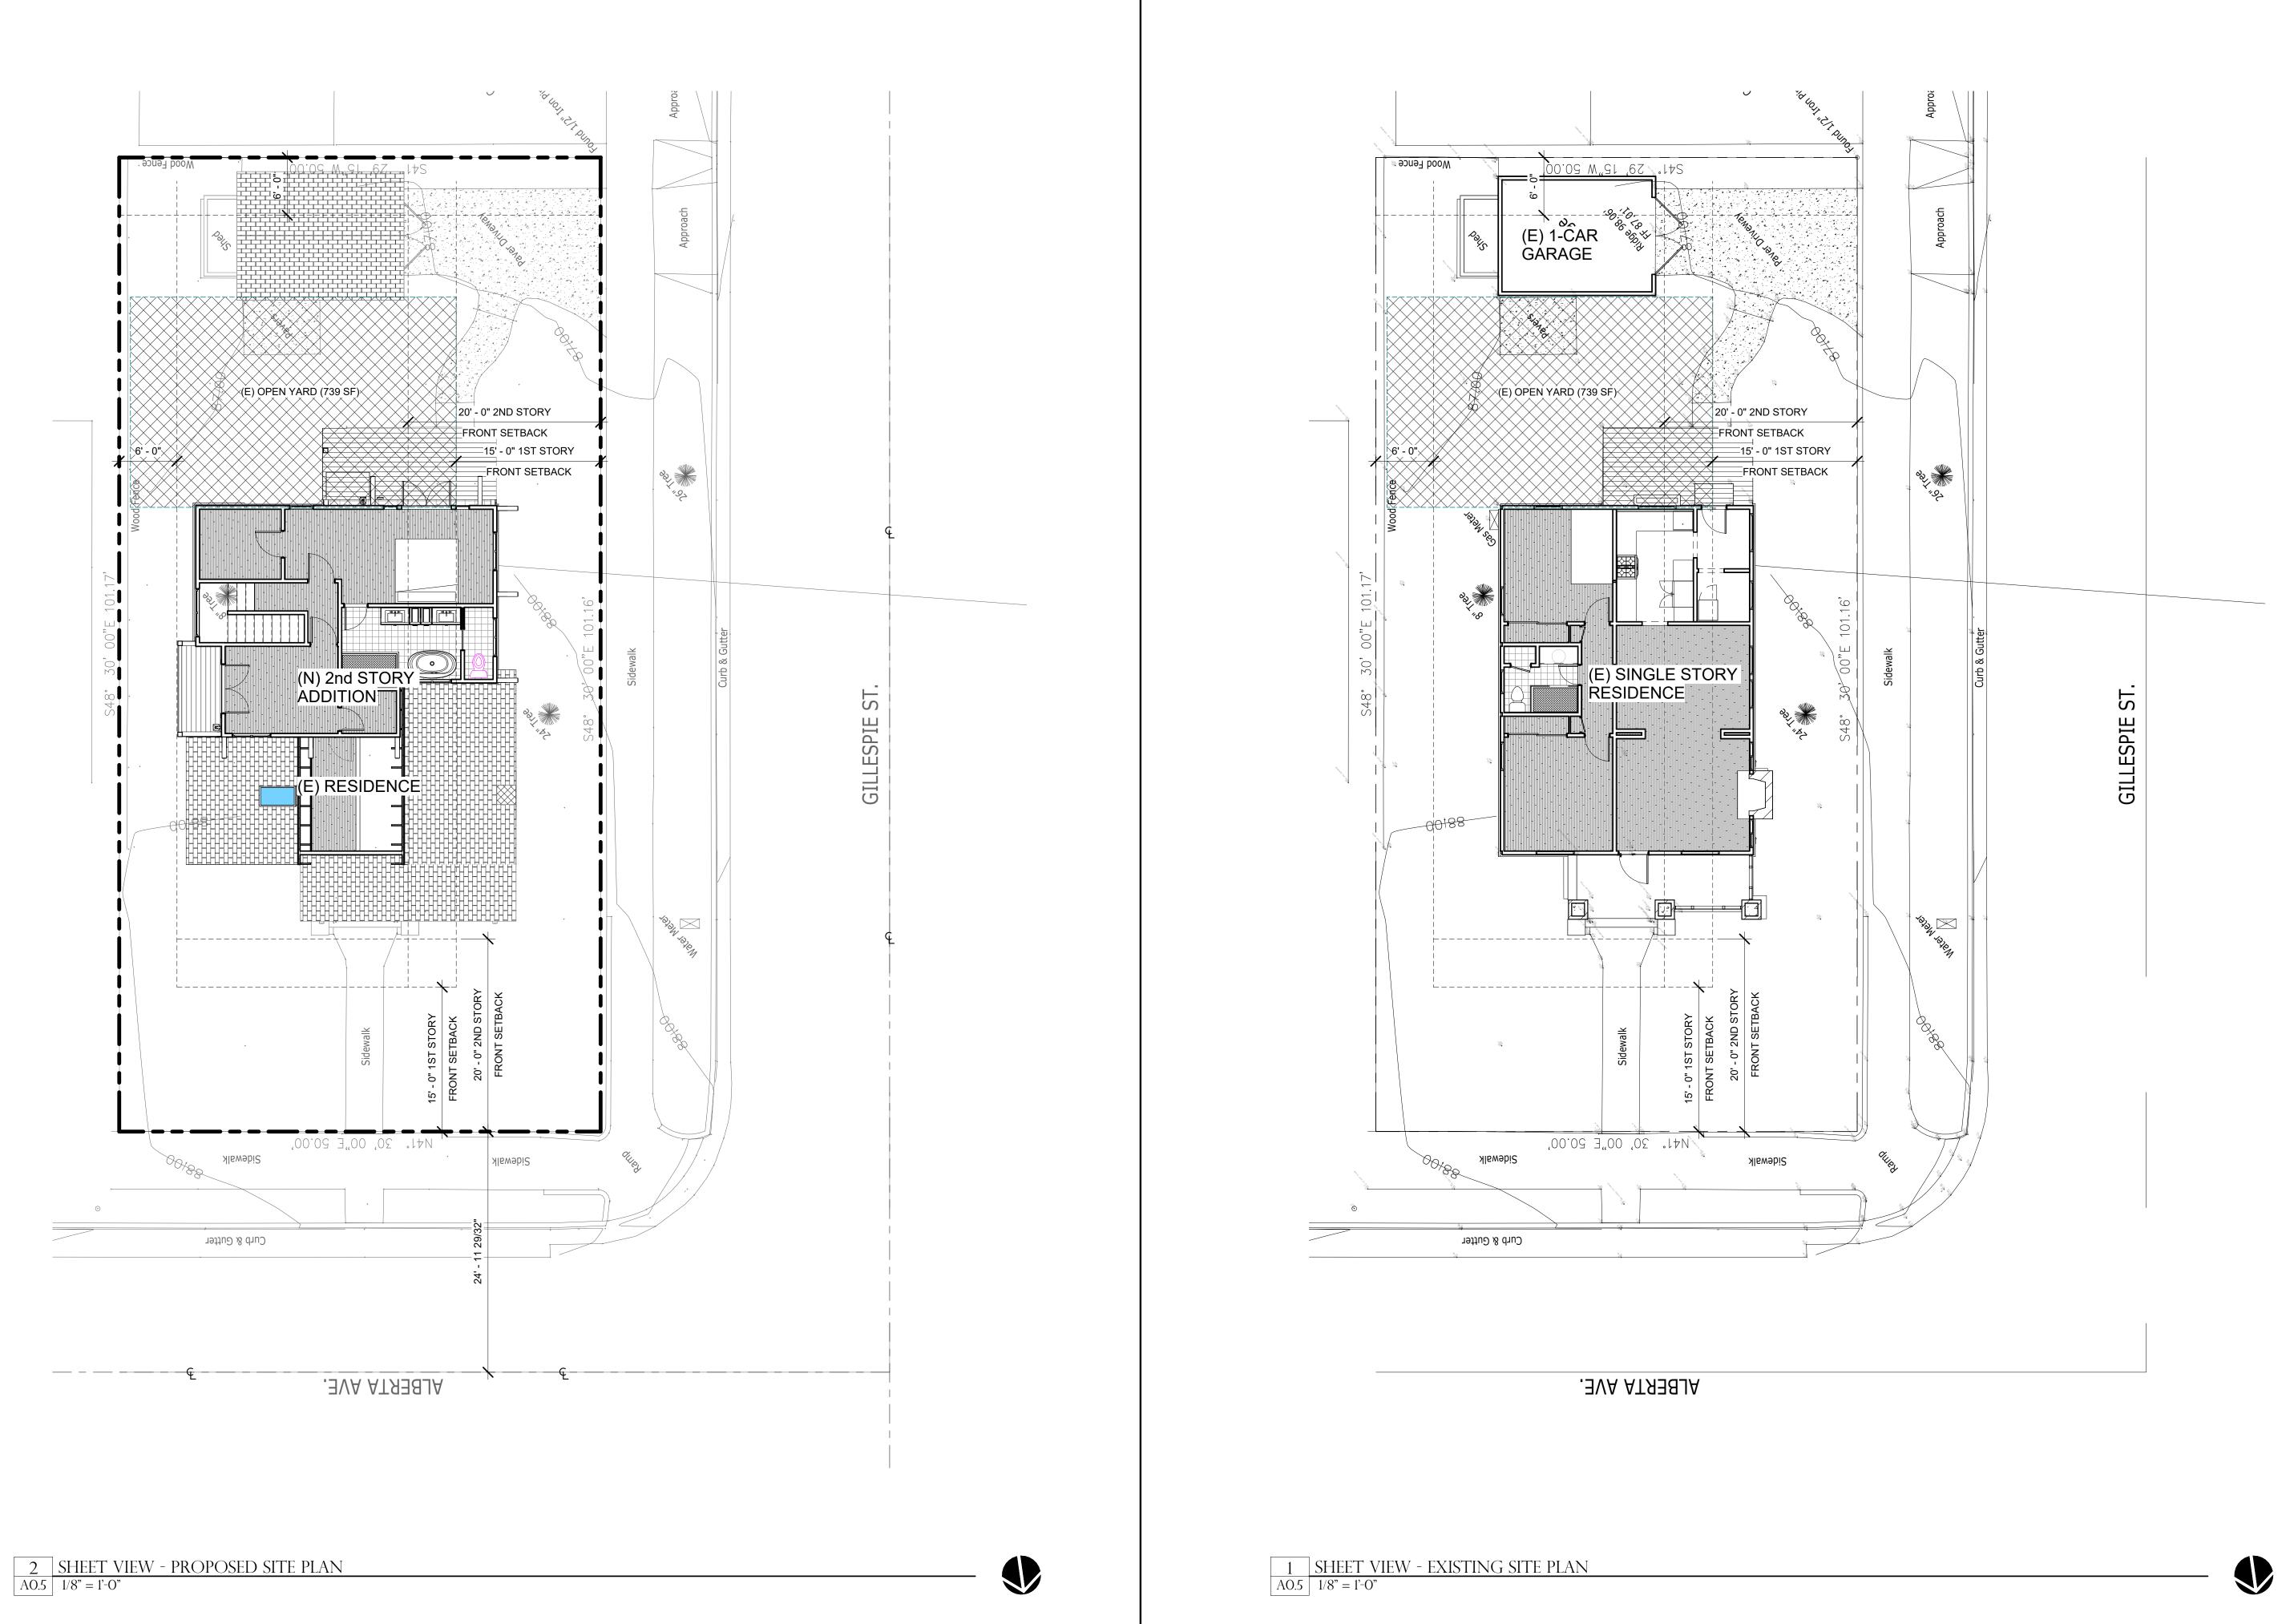
(E) PARKING - PRIMARY RESIDENCE: 1 COVERED / 0 UNCOVERED (N) PARKING - PRIMARY RESIDENCE: 1 COVERED / 0 UNCOVERED

NOTE: THIS BUILDING IS NOT FIRE SPRINKLERED

#	DESCRIP.	DATE

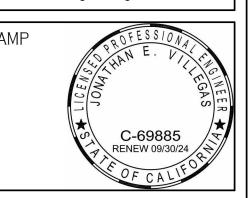
PROJECT NUMBER: 2022.019.00 07/16/2024 DRAWN BY: SHEET NO.







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AN A CA 93101 835 ALBERTA AV SANTA BARBARA C EXISTING AND PROPOS

BOTSFORD / BUDRECKIS RESIDE

No. Descript. Date

PROJECT NUMBER: 2022.019.00 07/16/2024 DRAWN BY:

SHEET NO.

DEMOLITION NOTES

DEFINITIONS:

- A. REMOVE: DETACH ITEMS FROM EXISTING CONSTRUCTION AND LEGALLY DISPOSE OF THEM OFF-SITE, UNLESS INDICATED TO BE REMOVED AND
- SALVAGED OR REMOVED AND REINSTALLED. B. REMOVE AND SALVAGE: DETACH ITEMS FROM EXISTING CONSTRUCTION AND DELIVER THEM TO OWNER.
- REMOVE AND REINSTALL: DETACH ITEMS FROM EXISTING CONSTRUCTION, PREPARE THEM FOR REUSE, AND REINSTALL THEM WHERE INDICATED. . EXISTING TO REMAIN: EXISTING ITEMS OF CONSTRUCTION THAT ARE NOT TO BE REMOVED AND THAT ARE NOT OTHERWISE INDICATED TO BE REMOVED,
- EXCEPT FOR ITEMS OR MATERIALS INDICATED TO BE REUSED, SALVAGED, REINSTALLED, OR OTHERWISE INDICATED TO REMAIN OWNER'S PROPERTY, DEMOLISHED MATERIALS SHALL BECOME CONTRACTOR'S PROPERTY AND SHALL

REMOVED AND SALVAGED, OR REMOVED AND REINSTALLED.

SUBMITTALS:

BE REMOVED FROM PROJECT SITE.

- A. PROPOSED CONTROL MEASURES: SUBMIT STATEMENT OR DRAWING THAT INDICATES THE MEASURES. INCLUDE MEASURES FOR THE FOLLOWING: a. DUST CONTROL.
- b. NOISE CONTROL. B. SCHEDULE OF SELECTIVE DEMOLITION ACTIVITIES: INDICATE DETAILED SEQUENCE OF SELECTIVE DEMOLITION AND REMOVAL WORK, WITH STARTING AND ENDING DATES FOR EACH ACTIVITY, INTERRUPTION OF UTILITY SERVICES, USE OF ELEVATOR AND STAIRS, AND LOCATIONS OF TEMPORARY PARTITIONS
- AND MEANS OF EGRESS. PRE-DEMOLITION PHOTOGRAPHS OR VIDEOTAPE: SHOW EXISTING CONDITIONS OF ADJOINING CONSTRUCTION AND SITE IMPROVEMENTS THAT MIGHT BE MISCONSTRUED AS DAMAGE CAUSED BY SELECTIVE DEMOLITION OPERATIONS. SUBMIT BEFORE WORK BEGINS.

QUALITY ASSURANCE:

- A. DEMOLITION FIRM QUALIFICATIONS: AN EXPERIENCED FIRM THAT IS SPECIALIZED IN DEMOLITION WORK SIMILAR IN MATERIAL AND EXTENT TO THAT
- INDICATED FOR THIS PROJECT. B. REGULATORY REQUIREMENTS: COMPLY WITH GOVERNING EPA NOTIFICATION REGULATIONS BEFORE BEGINNING SELECTIVE DEMOLITION. COMPLY WITH HAULING AND DISPOSAL REGULATIONS OF AUTHORITIES HAVING JURISDICTION. STANDARDS: COMPLY WITH ANSI A10.6 AND NFPA 241.
- D. PRE-DEMOLITION CONFERENCE: CONDUCT CONFERENCE AT PROJECT SITE. OWNER OR OWNERS REPRESENTATIVE MUST BE PRESENT AT THIS CONFERENCE.
- a. PRIOR TO CONFERENCE ON SITE, CONTRACTOR TO CLEARLY MARK ITEMS, FIXTURES, WALLS, WINDOWS, DOORS, APPLIANCES, ETC. WITH A SEMI-PERMANENT MARKING (LIKE COLORED TAPE) TO AID IN PRESENTING DEMOLITION ACTIVITIES TO BE PERFORMED.

REPAIR MATERIALS

- A. USE REPAIR MATERIALS IDENTICAL TO EXISTING MATERIALS. a. IF IDENTICAL MATERIALS ARE UNAVAILABLE OR CANNOT BE USED FOR EXPOSED SURFACES, USE MATERIALS THAT VISUALLY MATCH EXISTING ADJACENT SURFACES TO THE FULLEST EXTENT POSSIBLE.
- b. USE A MATERIAL WHOSE INSTALLED PERFORMANCE EQUALS OR SURPASSES THAT OF EXISTING MATERIALS.

EXAMINATION:

- A. VERIFY THAT UTILITIES HAVE BEEN DISCONNECTED AND CAPPED. B. SURVEY EXISTING CONDITIONS AND CORRELATE WITH REQUIREMENTS
- INDICATED TO DETERMINE EXTENT OF SELECTIVE DEMOLITION REQUIRED. INVENTORY AND RECORD THE CONDITION OF ITEMS TO BE REMOVED AND REINSTALLED AND ITEMS TO BE REMOVED AND SALVAGED.
- D. WHEN UNANTICIPATED MECHANICAL, ELECTRICAL, OR STRUCTURAL ELEMENTS THAT CONFLICT WITH INTENDED FUNCTION OR DESIGN ARE ENCOUNTERED, INVESTIGATE AND MEASURE THE NATURE AND EXTENT OF CONFLICT. PROMPTLY SUBMIT A WRITTEN REPORT TO ARCHITECT AND OWNER OR OWNER'S REPRESENTATIVES.
- ENGAGE A PROFESSIONAL ENGINEER TO SURVEY CONDITION OF BUILDING TO DETERMINE WHETHER REMOVING ANY ELEMENT MIGHT RESULT IN STRUCTURAL DEFICIENCY OR UNPLANNED COLLAPSE OF ANY PORTION OF STRUCTURE OR ADJACENT STRUCTURES DURING SELECTIVE DEMOLITION OPERATIONS.

UTILITY SERVICES

- A. EXISTING UTILITIES: MAINTAIN SERVICES INDICATED TO REMAIN AND PROTECT THEM AGAINST DAMAGE DURING SELECTIVE DEMOLITION OPERATIONS.
- B. DO NOT INTERRUPT EXISTING UTILITIES SERVING OCCUPIED OR OPERATING FACILITIES UNLESS AUTHORIZED IN WRITING BY OWNER AND AUTHORITIES HAVING JURISDICTION. PROVIDE TEMPORARY SERVICES DURING INTERRUPTIONS TO EXISTING UTILITIES, AS ACCEPTABLE TO OWNER AND TO AUTHORITIES HAVING JURISDICTION.
- a. PROVIDE AT LEAST 72 HOURS' NOTICE TO OWNER IF SHUTDOWN OF SERVICE IS REQUIRED DURING CHANGEOVER.
- C. UTILITY REQUIREMENTS: LOCATE, IDENTIFY, DISCONNECT, AND SEAL OR CAP OFF INDICATED UTILITIES SERVING AREAS TO BE SELECTIVELY DEMOLISHED. a. ARRANGE TO SHUT OFF INDICATED UTILITIES WITH UTILITY COMPANIES.
- b. IF UTILITY SERVICES ARE REQUIRED TO BE REMOVED, RELOCATED, OR ABANDONED, PROVIDE TEMPORARY UTILITIES BEFORE PROCEEDING WITH SELECTIVE DEMOLITION THAT BYPASS AREA OF SELECTIVE DEMOLITION AND THAT MAINTAIN CONTINUITY OF SERVICE TO OTHER PARTS OF
- CUT OFF PIPE OR CONDUIT IN WALLS OR PARTITIONS TO BE REMOVED. CAP, VALVE, OR PLUG AND SEAL REMAINING PORTION OF PIPE OR CONDUIT AFTER BYPASSING.
- UTILITY REQUIREMENTS: DO NOT START SELECTIVE DEMOLITION WORK UNTIL UTILITY DISCONNECTING AND SEALING HAVE BEEN COMPLETED AND VERIFIED IN WRITING.

PREPARATION:

- A. SITE ACCESS AND TEMPORARY CONTROLS: CONDUCT SELECTIVE DEMOLITION AND DEBRIS-REMOVAL OPERATIONS TO ENSURE MINIMUM INTERFERENCE WITH ROADS, STREETS, WALKS, WALKWAYS, AND OTHER ADJACENT OCCUPIED AND USED FACILITIES.
- a. DO NOT CLOSE OR OBSTRUCT STREETS, WALKS, WALKWAYS, OR OTHER ADJACENT OCCUPIED OR USED FACILITIES WITHOUT PERMISSION FROM OWNER, BUILDING MANAGER, AND AUTHORITIES HAVING JURISDICTION. PROVIDE ALTERNATE ROUTES AROUND CLOSED OR OBSTRUCTED TRAFFIC WAYS IF REQUIRED BY GOVERNING REGULATIONS.
- b. ERECT TEMPORARY PROTECTION, SUCH AS WALKS, FENCES, RAILINGS, CANOPIES, AND COVERED PASSAGEWAYS, WHERE REQUIRED BY AUTHORITIES HAVING JURISDICTION.
- PROTECT EXISTING SITE IMPROVEMENTS, APPURTENANCES, AND LANDSCAPING TO REMAIN.
- TEMPORARY FACILITIES: PROVIDE TEMPORARY BARRICADES AND OTHER PROTECTION REQUIRED TO PREVENT INJURY TO PEOPLE AND DAMAGE TO ADJACENT BUILDINGS AND FACILITIES TO REMAIN.
- TEMPORARY ENCLOSURES: PROVIDE TEMPORARY ENCLOSURES FOR PROTECTION OF EXISTING BUILDING AND CONSTRUCTION, IN PROGRESS AND COMPLETED, FROM EXPOSURE, FOUL WEATHER, OTHER CONSTRUCTION OPERATIONS, AND SIMILAR ACTIVITIES. PROVIDE TEMPORARY WEATHERTIGHT ENCLOSURE FOR BUILDING EXTERIOR.
- D. TEMPORARY PARTITIONS: ERECT AND MAINTAIN DUSTPROOF PARTITIONS AND TEMPORARY ENCLOSURES TO LIMIT DUST AND DIRT MIGRATION AND TO SEPARATE AREAS FROM FUMES AND NOISE.
- TEMPORARY SHORING: PROVIDE AND MAINTAIN INTERIOR AND EXTERIOR SHORING, BRACING, OR STRUCTURAL SUPPORT TO PRESERVE STABILITY AND PREVENT MOVEMENT, SETTLEMENT, OR COLLAPSE OF CONSTRUCTION TO REMAIN, AND TO PREVENT UNEXPECTED OR UNCONTROLLED MOVEMENT OR COLLAPSE OF CONSTRUCTION BEING DEMOLISHED.

DEMOLITION NOTES CONT.

9. POLLUTION CONTROLS

- A. DUST CONTROL: USE WATER MIST, TEMPORARY ENCLOSURES, AND OTHER SUITABLE METHODS TO LIMIT SPREAD OF DUST AND DIRT. COMPLY WITH GOVERNING ENVIRONMENTAL-PROTECTION REGULATIONS.
- a. WET MOP FLOORS TO ELIMINATE TRACKABLE DIRT AND WIPE DOWN WALLS AND DOORS OF DEMOLITION ENCLOSURE. VACUUM CARPETED AREAS. B. DISPOSAL: REMOVE AND TRANSPORT DEBRIS IN A MANNER THAT WILL
- PREVENT SPILLAGE ON ADJACENT SURFACES AND AREAS. REMOVE DEBRIS FROM ELEVATED PORTIONS OF BUILDING BY CHUTE, HOIST, OR OTHER DEVICE THAT WILL CONVEY DEBRIS TO GRADE LEVEL IN A
- CONTROLLED DESCENT. C. CLEANING: CLEAN ADJACENT STRUCTURES AND IMPROVEMENTS OF DUST, DIRT, AND DEBRIS CAUSED BY SELECTIVE DEMOLITION OPERATIONS. RETURN ADJACENT AREAS TO CONDITION EXISTING BEFORE SELECTIVE DEMOLITION

OPERATIONS BEGAN.

10. SELECTIVE DEMOLITION

- A. GENERAL: DEMOLISH AND REMOVE EXISTING CONSTRUCTION ONLY TO THE EXTENT REQUIRED BY NEW CONSTRUCTION AND AS INDICATED. USE METHODS REQUIRED TO COMPLETE THE WORK WITHIN LIMITATIONS OF GOVERNING
- REGULATIONS. a. NEATLY CUT OPENINGS AND HOLES PLUMB, SQUARE, AND TRUE TO DIMENSIONS REQUIRED. USE CUTTING METHODS LEAST LIKELY TO DAMAGE
- CONSTRUCTION TO REMAIN OR ADJOINING CONSTRUCTION. b. CUT OR DRILL FROM THE EXPOSED OR FINISHED SIDE INTO CONCEALED SURFACES TO AVOID MARRING EXISTING FINISHED SURFACES.
- c. DO NOT USE CUTTING TORCHES UNTIL WORK AREA IS CLEARED OF FLAMMABLE MATERIALS. AT CONCEALED SPACES, SUCH AS DUCT AND PIPE INTERIORS, VERIFY CONDITION AND CONTENTS OF HIDDEN SPACE BEFORE STARTING FLAME-CUTTING OPERATIONS. MAINTAIN FIRE WATCH AND PORTABLE FIRE-SUPPRESSION DEVICES DURING FLAME-CUTTING
- OPERATIONS. d. LOCATE SELECTIVE DEMOLITION EQUIPMENT AND REMOVE DEBRIS AND MATERIALS SO AS NOT TO IMPOSE EXCESSIVE LOADS ON SUPPORTING WALLS, FLOORS, OR FRAMING.
- B. EXISTING FACILITIES: COMPLY WITH OWNER OR BUILDING MANAGER'S REQUIREMENTS FOR USING AND PROTECTING ELEVATORS, STAIRS, WALKWAYS, LOADING DOCKS, BUILDING ENTRIES, AND OTHER BUILDING FACILITIES DURING SELECTIVE DEMOLITION OPERATIONS.

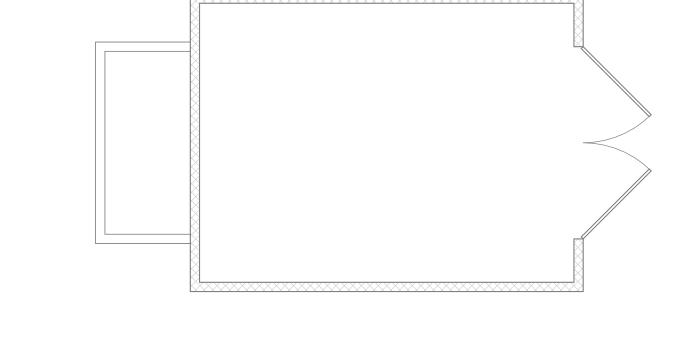
WALL LEGEND

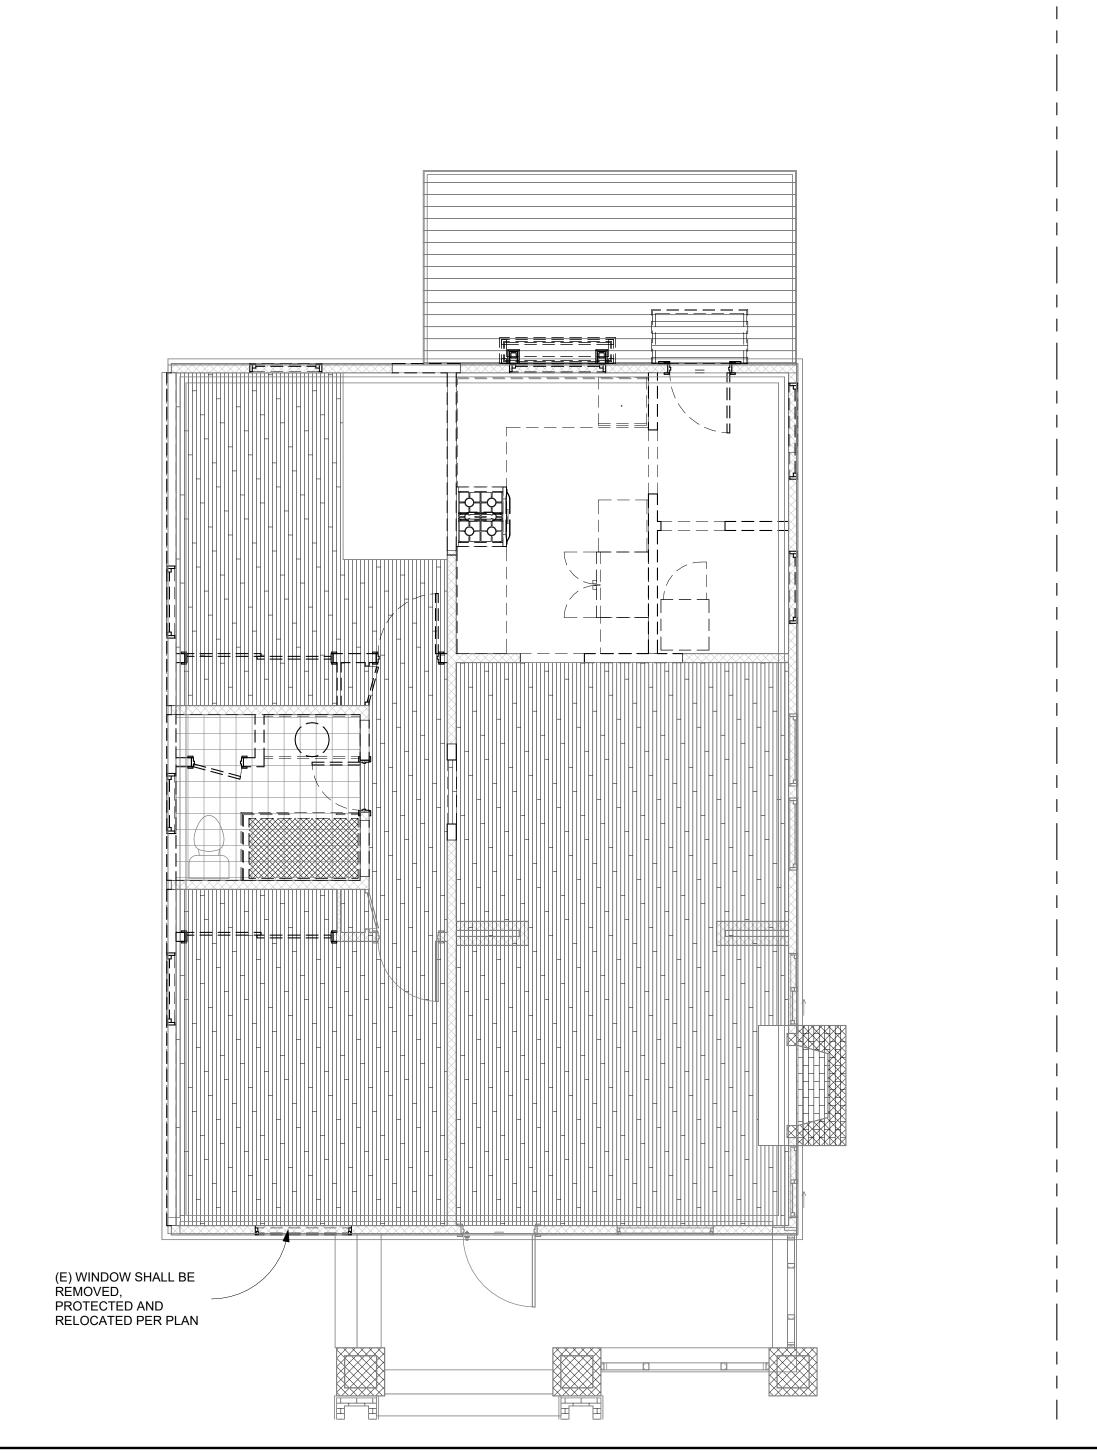
PROPOSED WOOD STUD WALL

EXISTING WOOD STUD WALL

EXISTING WALL TO BE DEMOLISHED

SHEET VIEW - DEMO LOWER FLOOR PLAN







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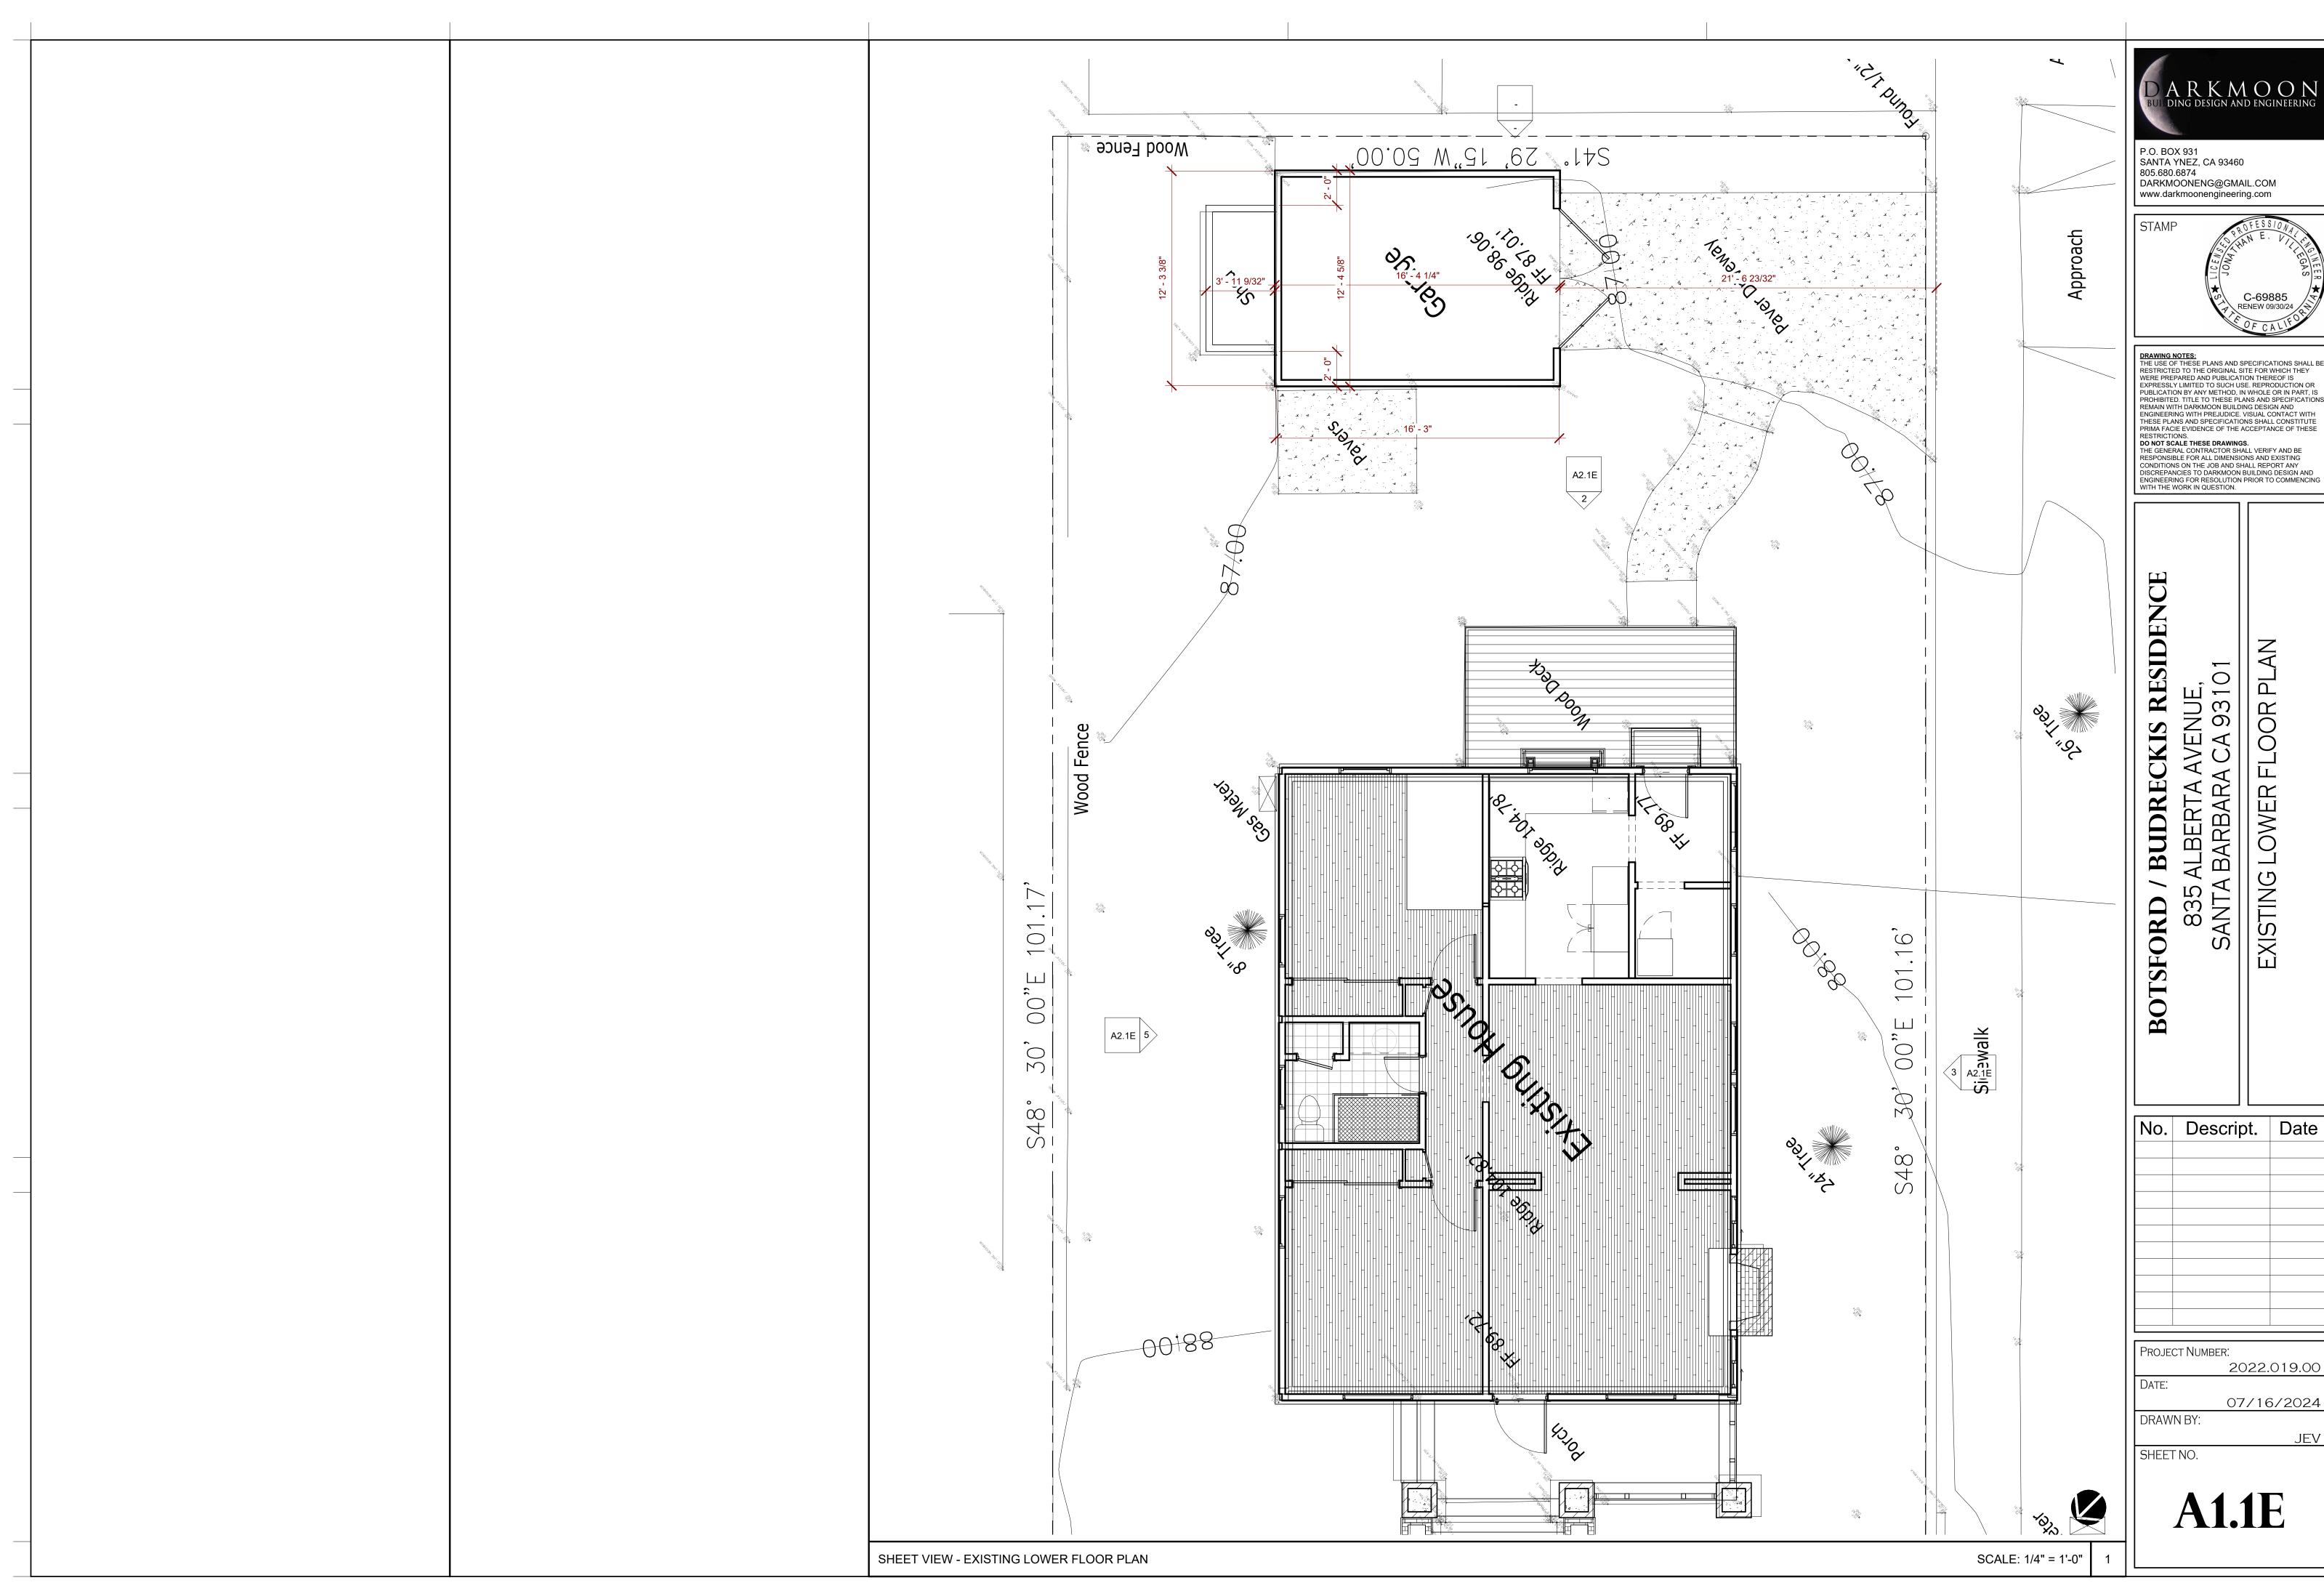
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No.	Descript.	Date		

PROJECT NUMBER: 2022.019.00 07/16/2024 DRAWN BY: SHEET NO.

SCALE: 1/4" = 1'-0"





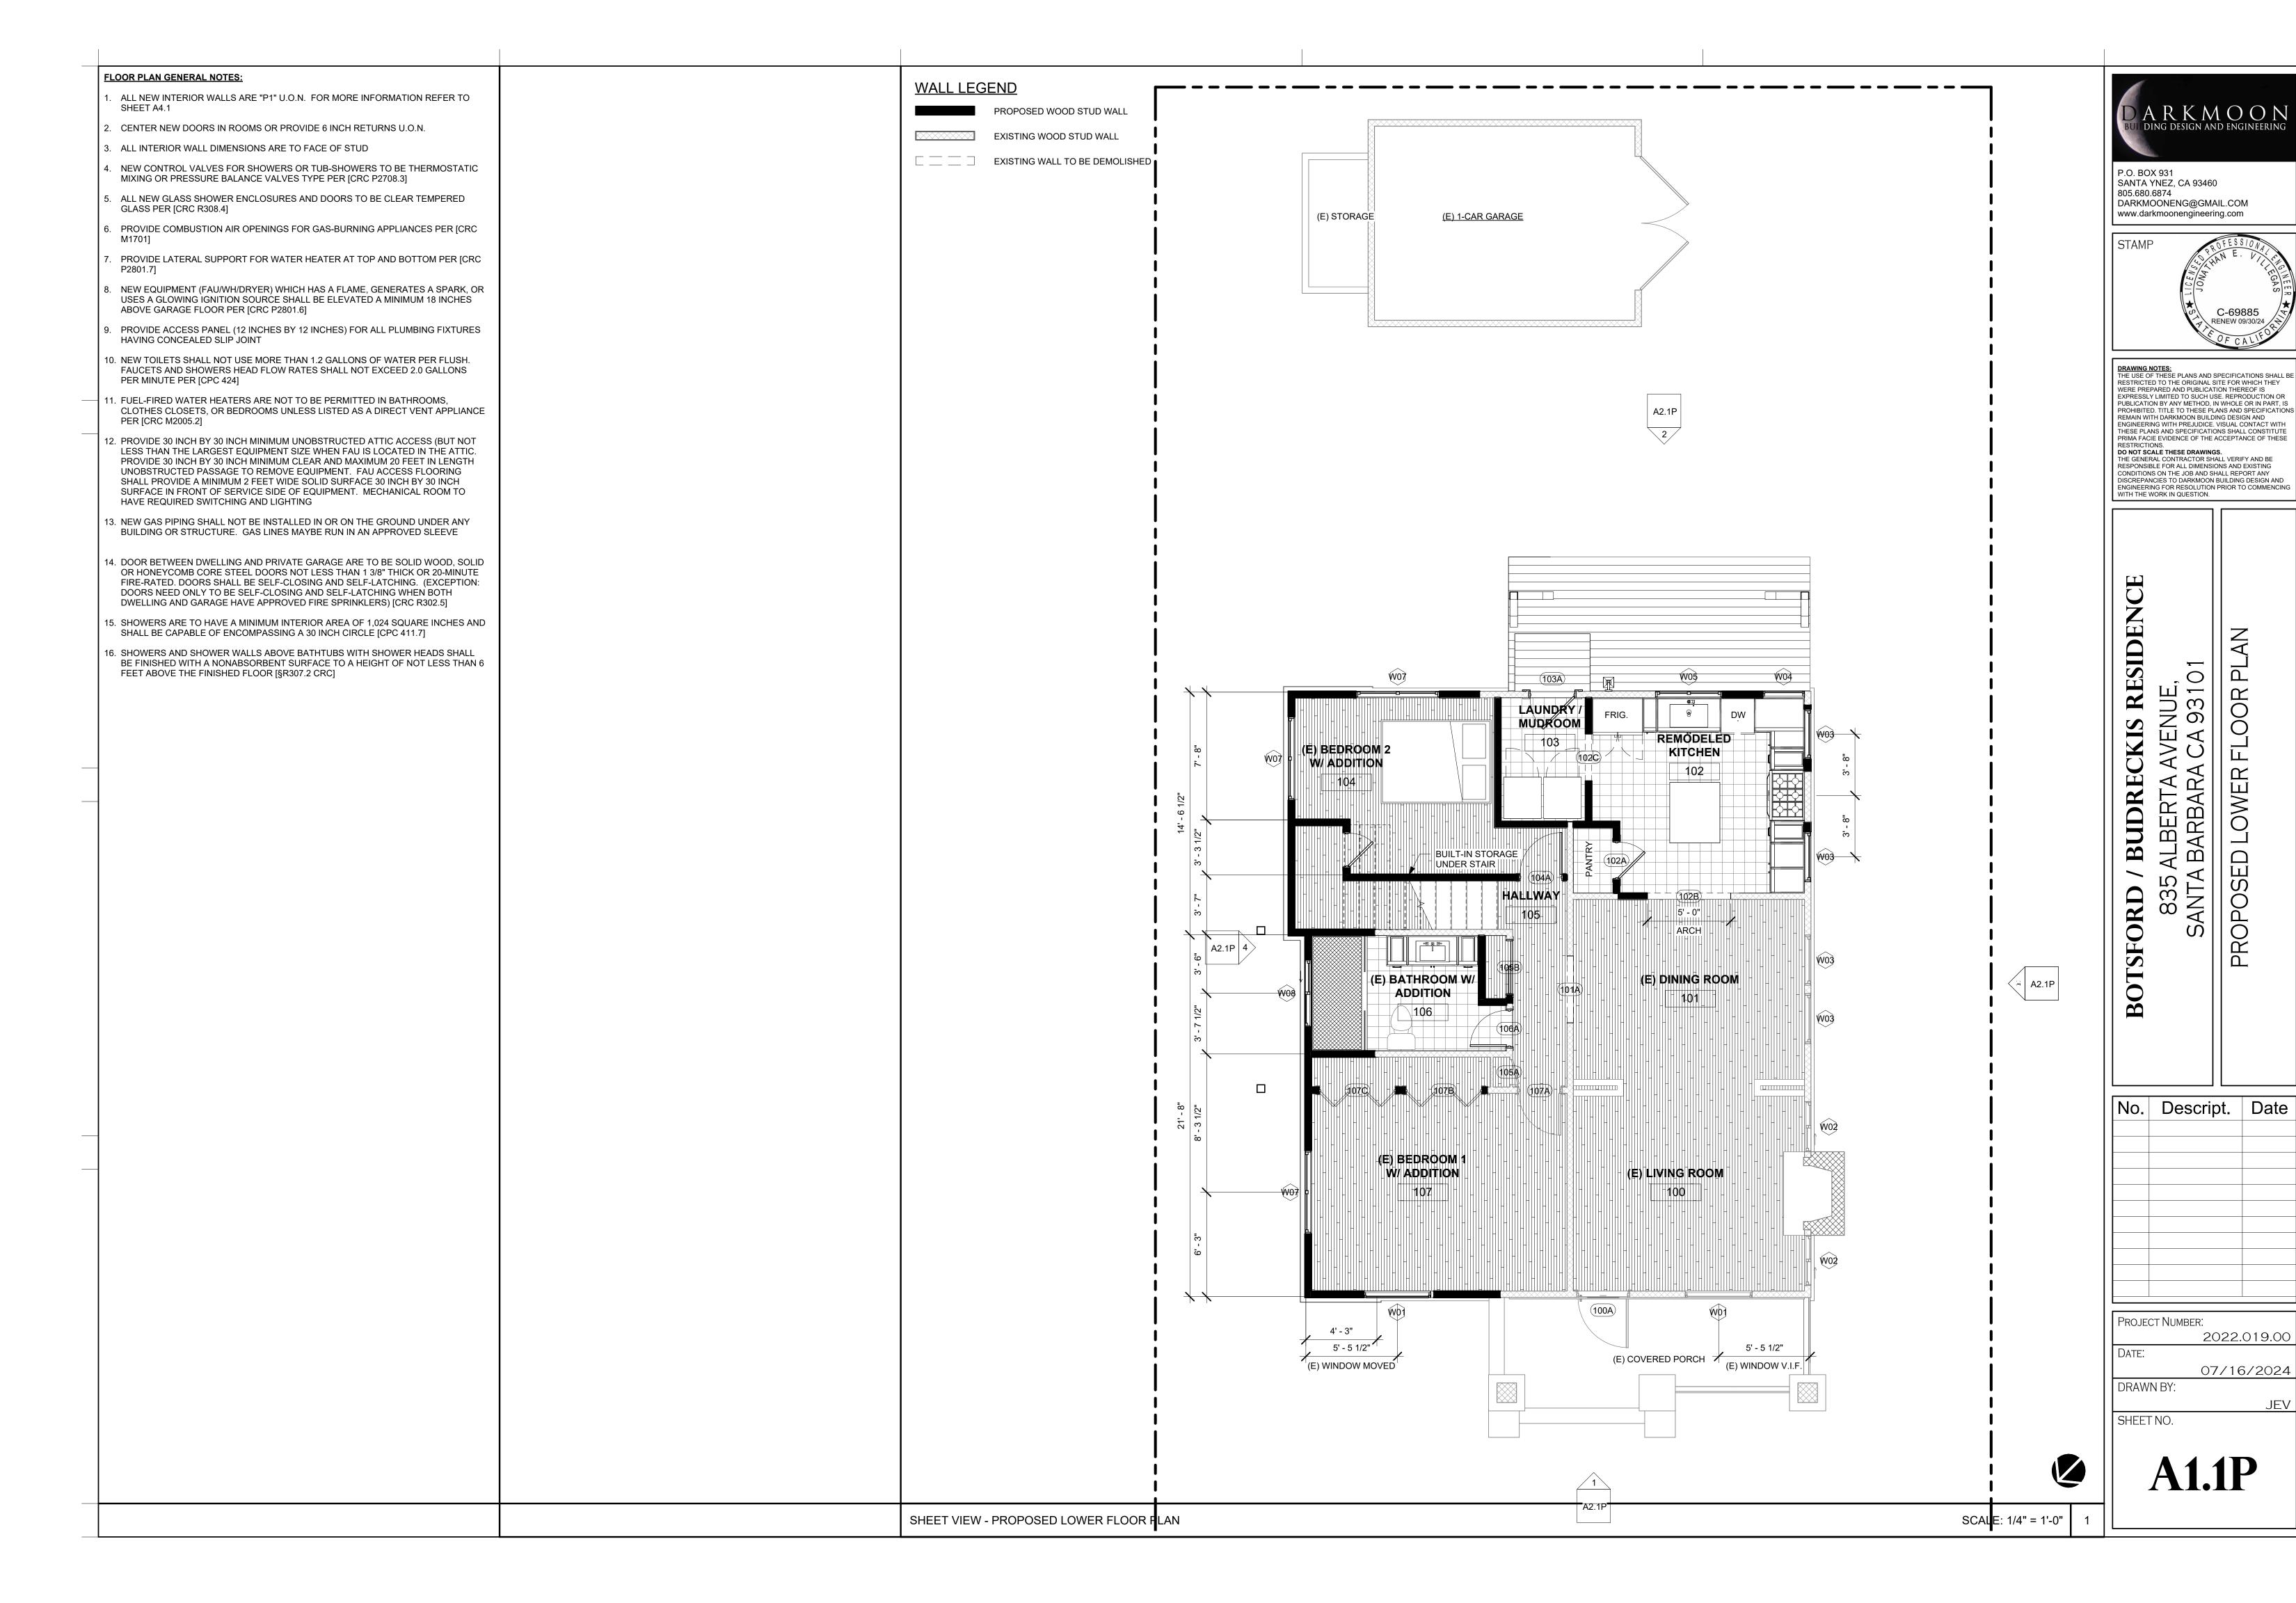
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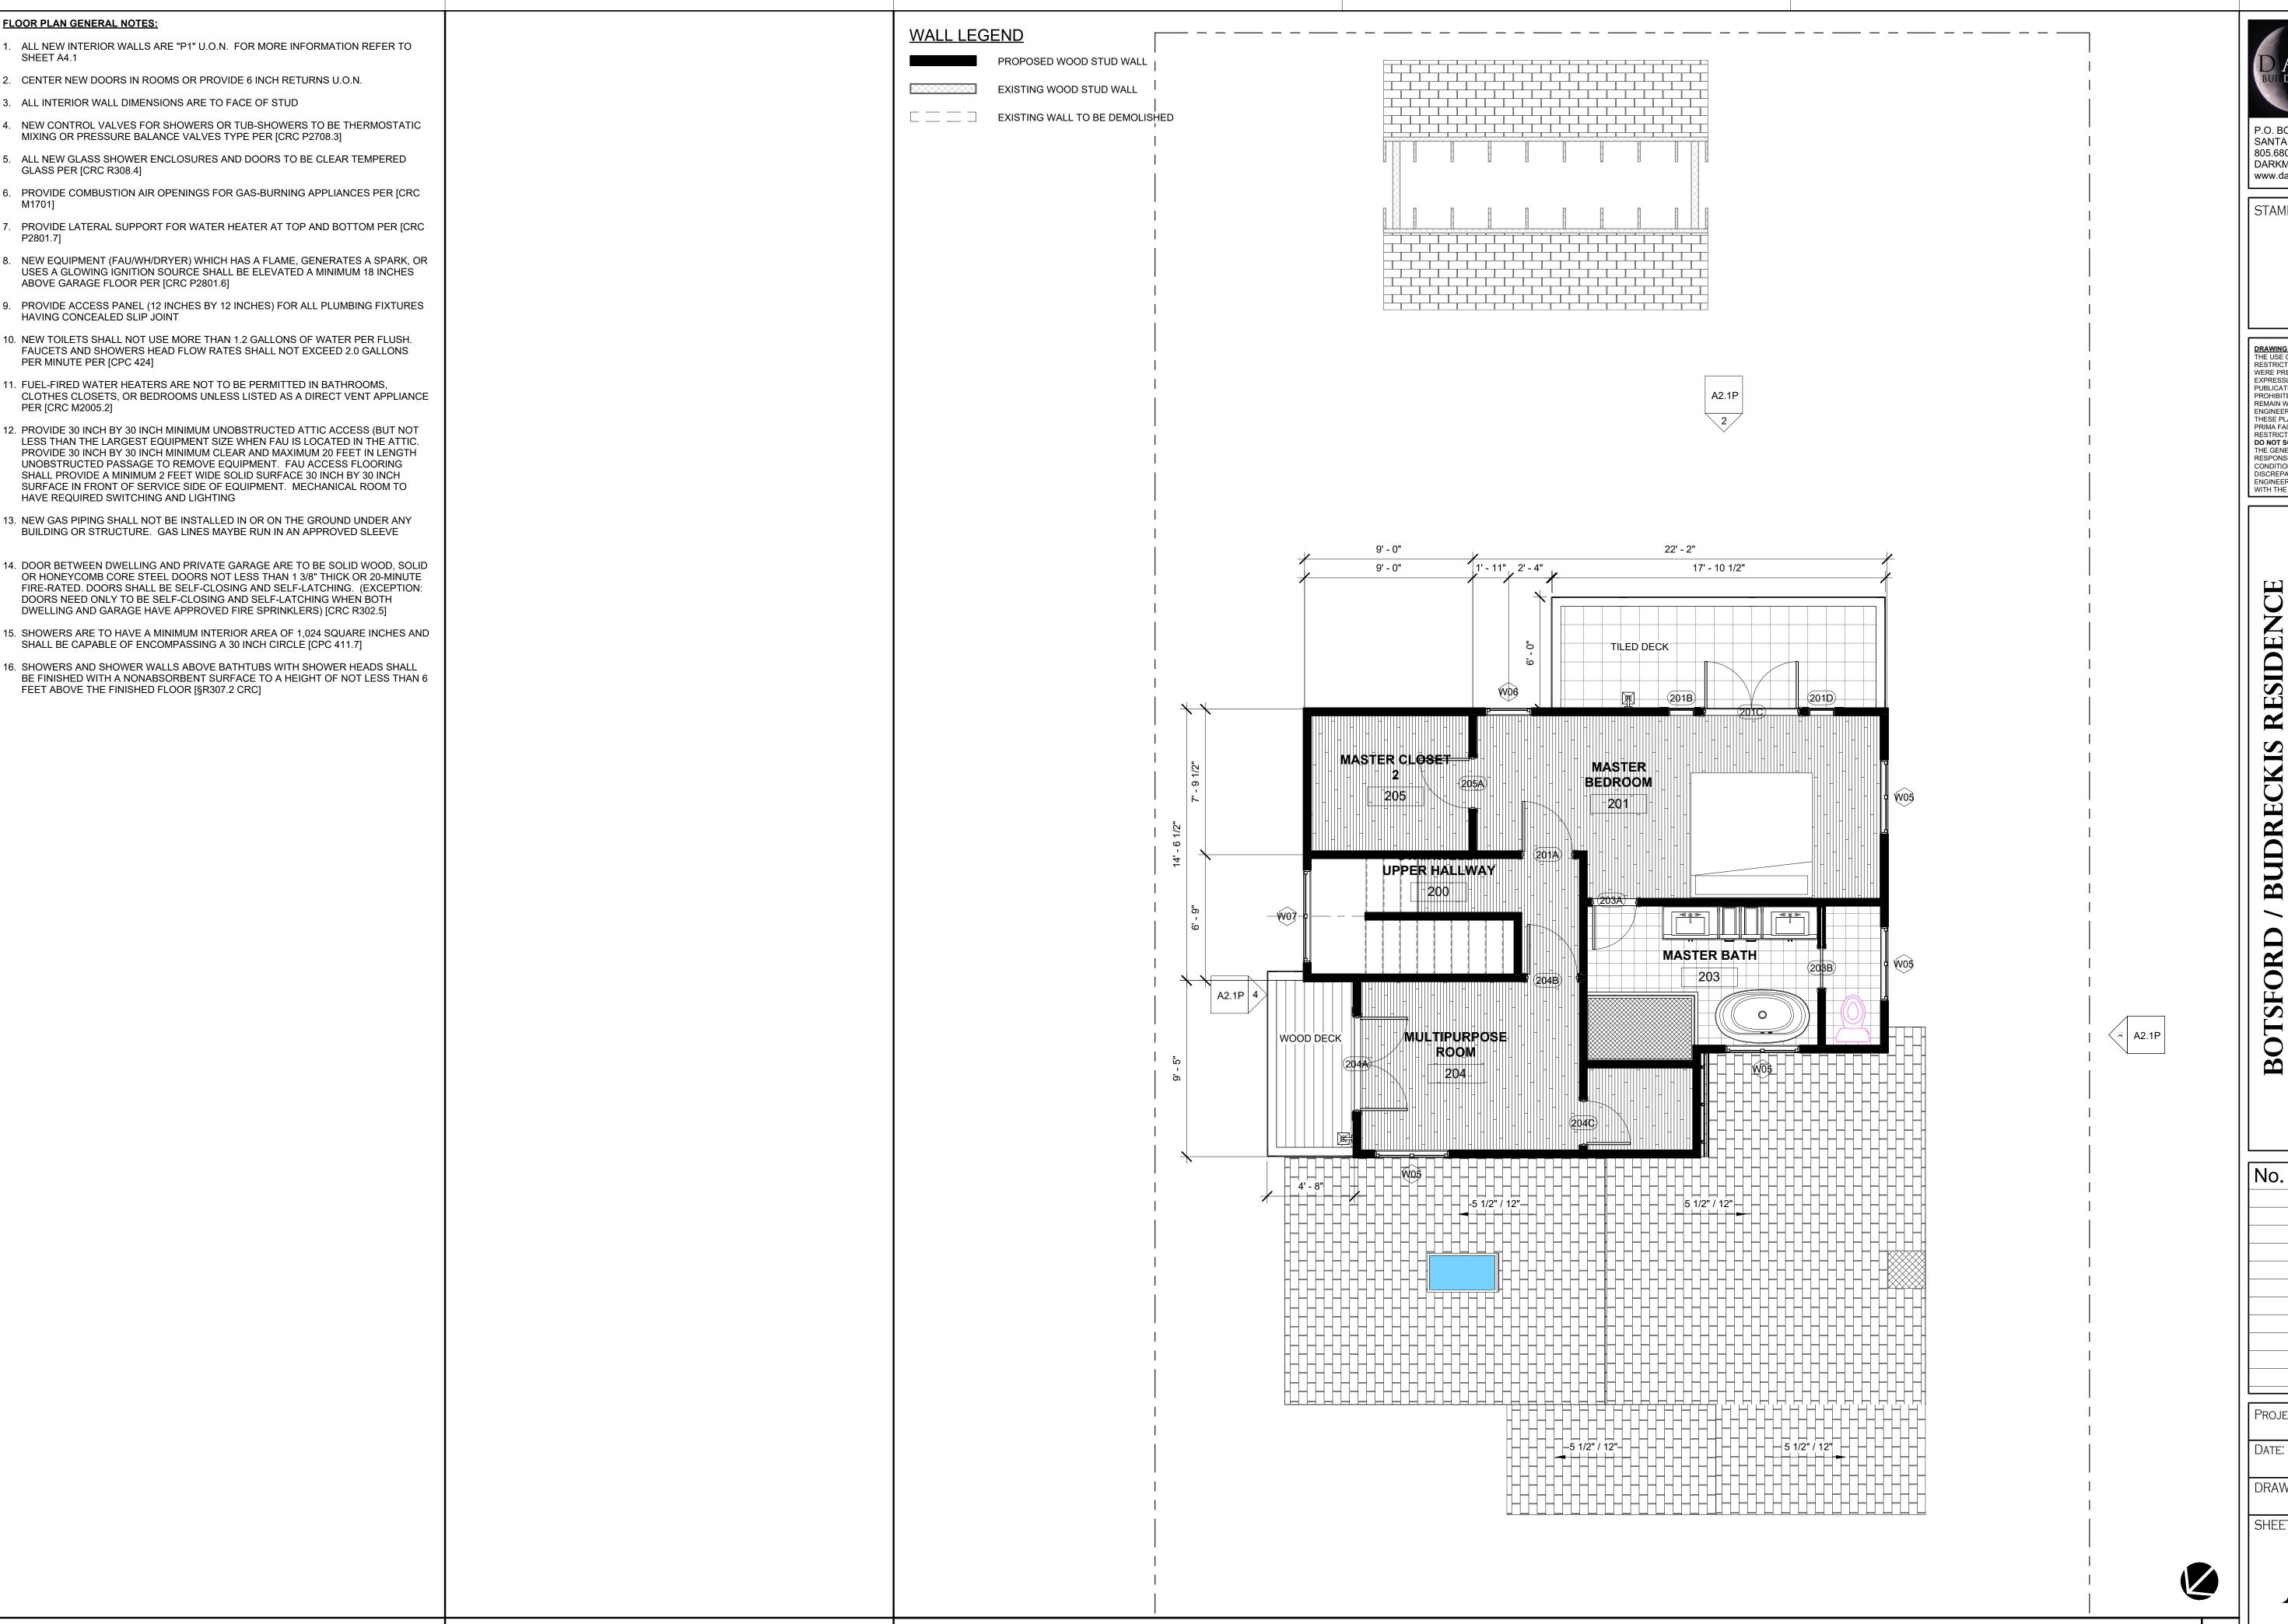
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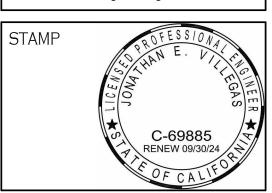
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SHEET VIEW - PROPOSED UPPER FLOOR PLAN



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FORD / BUDRECKIS RE 835 ALBERTA AVENUE, SANTA BARBARA CA 9310

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PROPOSED (

No. Descript. Date

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2022.019.00

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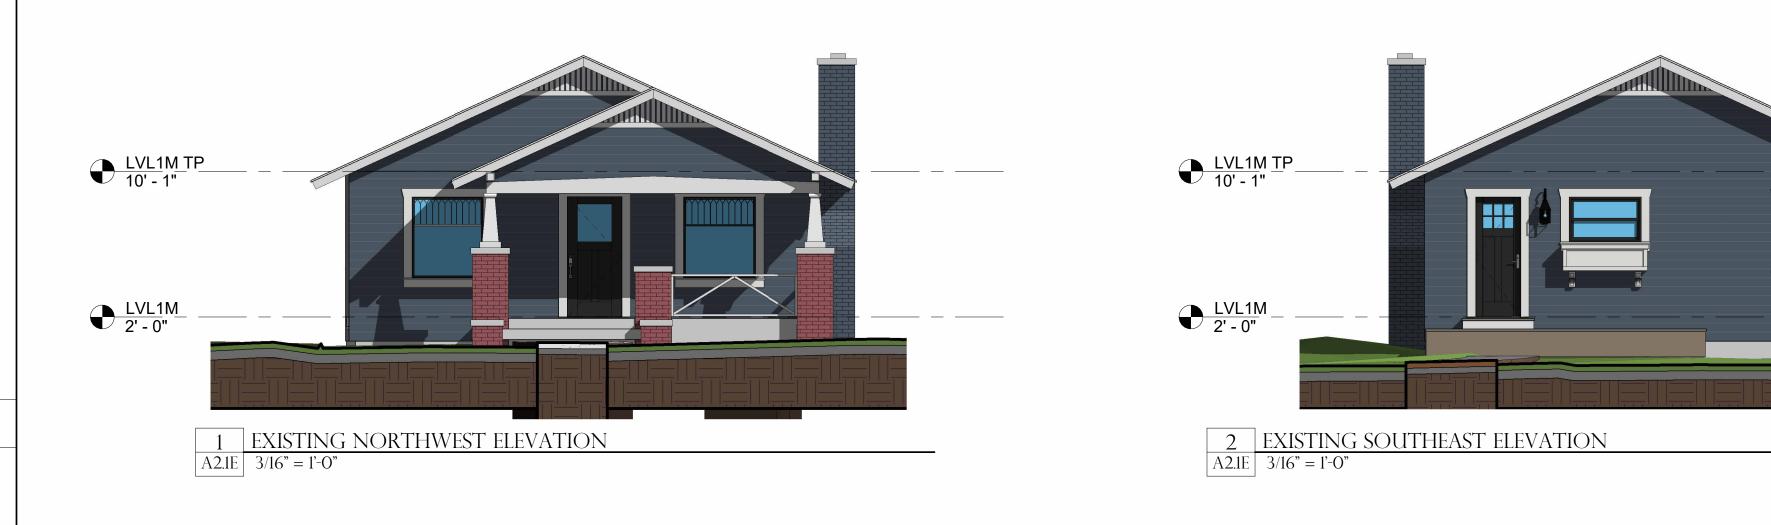
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SHEET NO.

SCALE: 1/4" = 1'-0"

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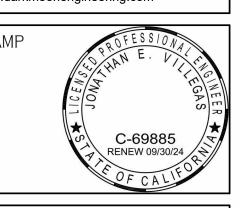








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BOTSFORD / BUDRECKIS RESIDENCI 835 ALBERTA AVENUE, SANTA BARBARA CA 93101 EXISTING EXTERIOR ELEVATIONS

No. Descript. Date

PROJECT NUMBER:

2022.019.00

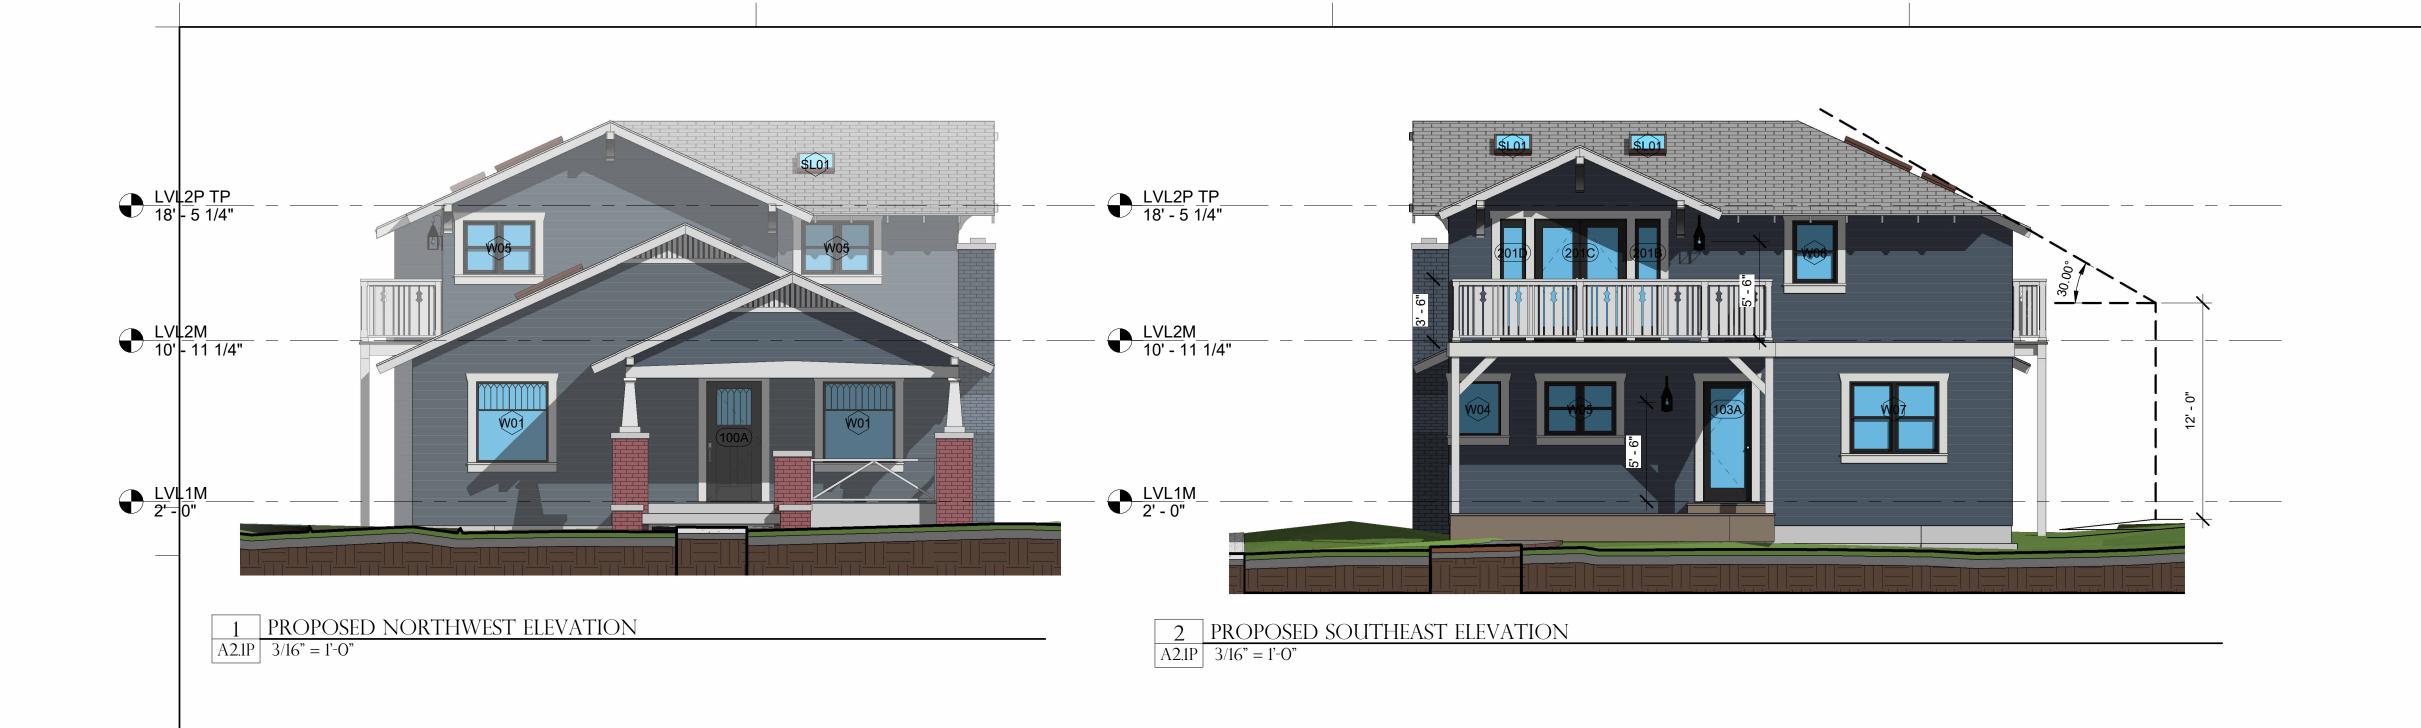
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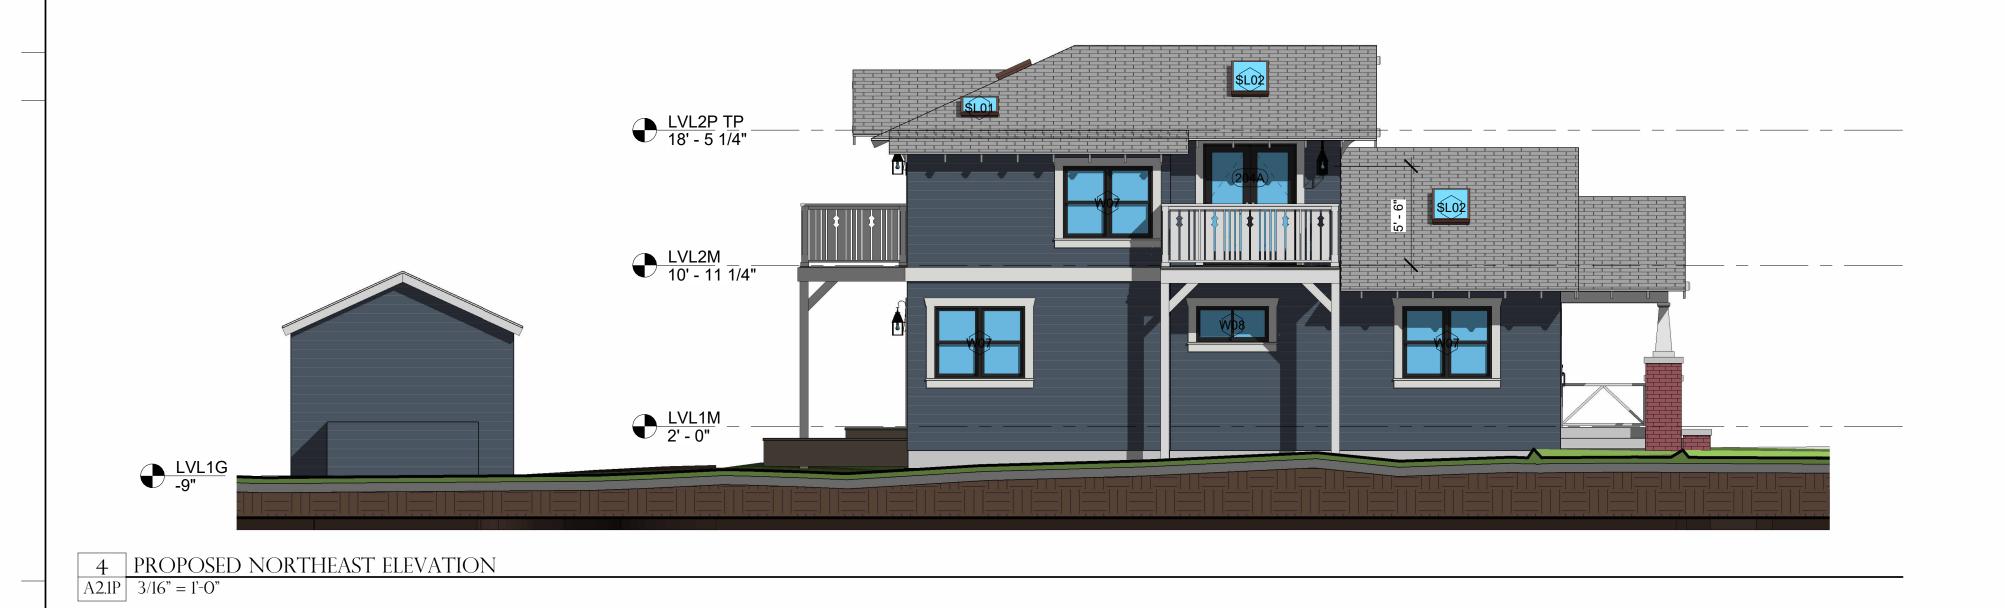
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A2.1E



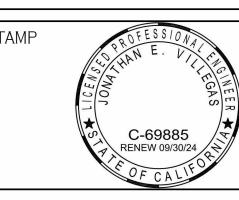


3 PROPOSED SOUTHWEST ELEVATION A2.1P 3/16" = 1'-0"





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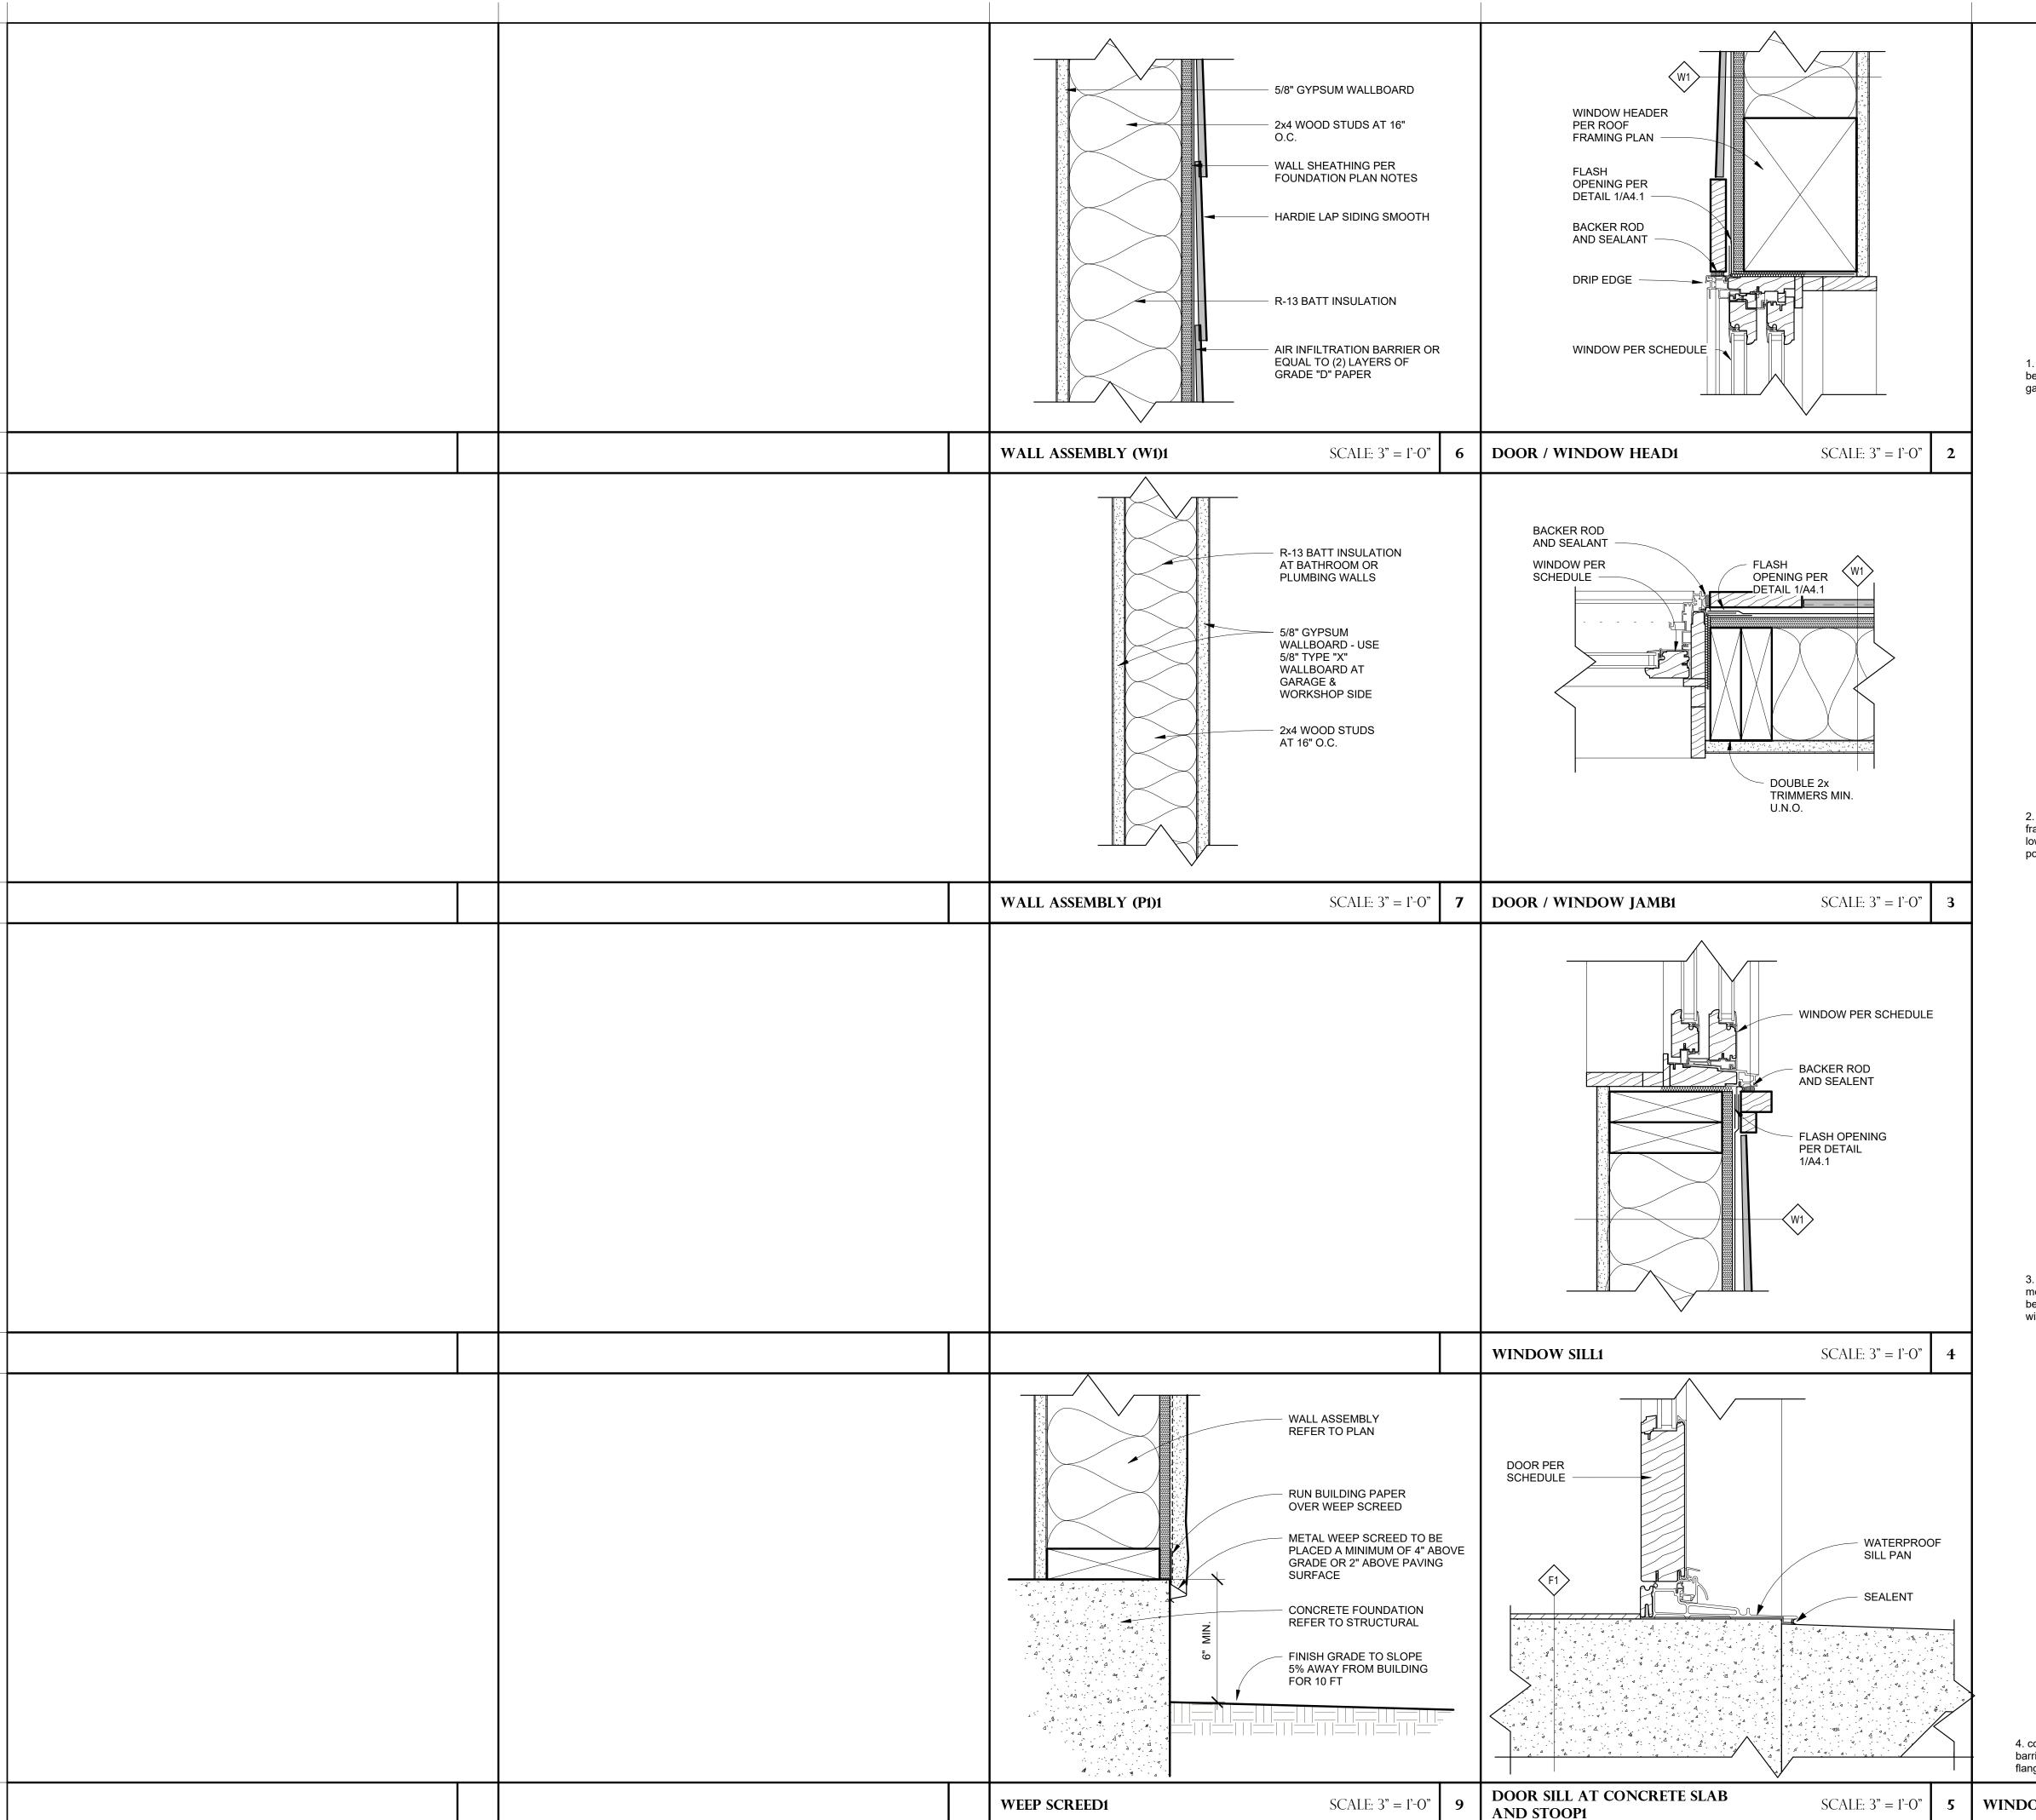
PROPOSED EXTERIOR ELEVATIONS

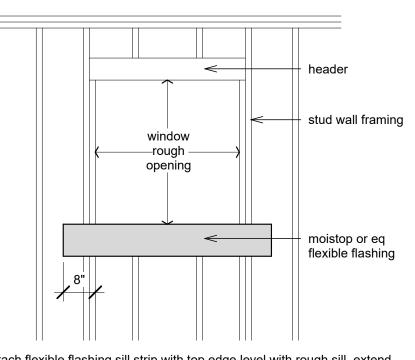
BOTSFORD / BUDRECKIS RESIDEN 835 ALBERTA AVENUE, SANTA BARBARA CA 93101

No.	Descript.	Date	

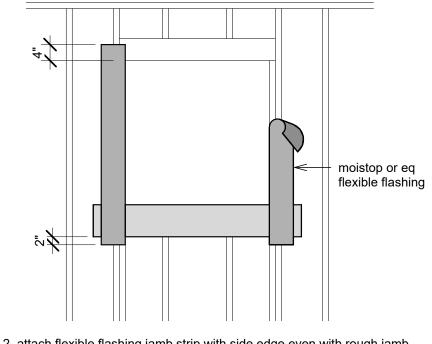
PROJECT NUMBER: 2022.019.00 07/16/2024 DRAWN BY: SHEET NO.

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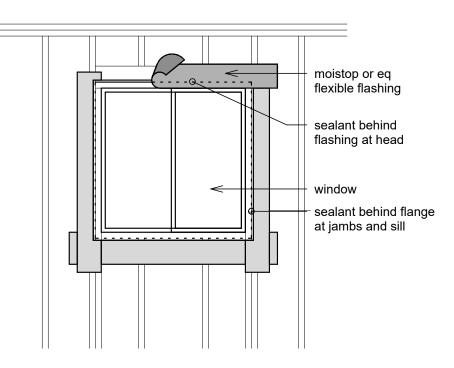




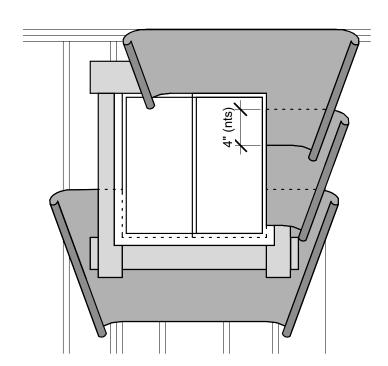
1. attach flexible flashing sill strip with top edge level with rough sill, extend beyond edge of rough opening at least 8", secure all moistop (or eq) with galvanized nails or power-driven staples.



 attach flexible flashing jamb strip with side edge even with rough jamb framing, start strip 1" below lower edge of sill strip and extend 4" above lower edge of header, secure moistop (or eq) with galvanized nails or power-driven staples.



3. install window and jamb flanges over a continuous bead of sealant on the moistop (or eq), install the window head flexible flashing on a continuous bead of sealant applied to the window head flange, secure all moistop (or eq) with galvanized nails or power-driven staples.

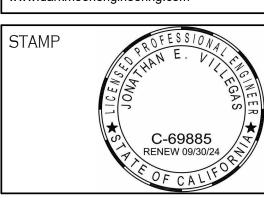


4. commencing at the bottom (sole plate) of the wall, lay weather resistive barrier under sill strip, install successive layers over window jamb and head flanges, with 4" lap at each horizontal overlap and 12" at each vertical overlap

WINDOW FLASHING1 SCALE: 1/2" = 1'-0"



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BOTSFORD / BUDRECKIS RESIDENC 835 ALBERTA AVENUE, SANTA BARBARA CA 93101 ARCHITECTURAL DETAILS

No.	Descript.	Date		

- 1	
	PROJECT NUMBER:
	2022.019.00
	Date:
	07/16/2024
	DRAWN BY:
	JEV
	SHEET NO.

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	384 77	DECOMPTION:	Harry.	TIETO	DOOR S			1	COMMUNITY OF THE		DOOR 8	& WINDOW AE	BBREVIA	ATIONS
E	MARK	DESCRIPTION CASED WALL OPENING	WIDTH 4' - 0"	HEIGHT 6' - 8"	HARDWARE FIN	NISH	MANUFACTURER NOT APLICABLE		COMMENTS		ALUM = BF =	ALUMINUM BI-FOLD	P = PH =	PAINT PANIC HARDWARE
- 5	101A 102A	FRENCH DOOR	2' - 2"	6' - 8"			KOLBE				CL = GL =	CLOSET GLASS	PR = PF =	PAIR PRE-FINISHED
- 1	102B 102C	CASED WALL OPENING CASED WALL OPENING	5' - O" 2' - 10"	6' - 8" 6' - 8"			NOT APLICABLE NOT APLICABLE				HCW = HM =	HOLLOW CORE WOOD HOLLOW METAL	RM = RO =	REMOVABLE MULL ROUGH OPENING
	102K 103A	SOLID CORE DOOR FRENCH DOOR	2' - 0" 2' - 8"	6' - 0" 6' - 8"			PER OWNER Kolbe				CF = CP = CSMT =	CLEAR FINISH COPPER CASEMENT	SCW = STL = T =	SOLID CORE WOO STEEL TEMPERED
	104A 105B	SOLID CORE DOOR CLOSET SLIDER DOOR	2' - 6" 3' - 2"	6' - 8" 6' - 8"			PER OWNER PER OWNER				FA = FG =	FACTORY FIBER GLASS	TR = VGDF =	TERRACE VERTICAL GRAIN I
	106A 107B	SOLID CORE DOOR BI-FOLD CLOSET DOOR	2' - 2" 4' - 6"	6' - 8" 6' - 8"			PER OWNER PER OWNER				FX = LG =	FIXED LAMINATED GLASS	WD = SS =	WOOD SMOKE SEAL
	107C 201A	BI-FOLD CLOSET DOOR SOLID CORE DOOR	4' - 6" 2' - 8"	6' - 8" 6' - 8"			PER OWNER PER OWNER				MANUF = CLR.ANNOD =	MANUFACTURED CLEAR ANNODIZED	ST= § =	STAIN SECURITY PROVIS
	201B 201C	SIDE LITE DOOR DOUBLE FRENCH DOORS	1' - 3" 5' - O"	6' - 8" 6' - 8"			KOLBE Kolbe				1			
	201D 203A	SIDE LITE DOOR SOLID CORE DOOR	1' - 3" 2' - 4"	6' - 8" 6' - 8"			KOLBE PER OWNER				<u> </u>			
	203B 204A	SOLID CORE POCKET DOOR DOUBLE FRENCH DOORS	2' - 2" 5' - 0"	6' - 8" 6' - 8"			PER OWNER KOLBE							
	204B 204C	SOLID CORE DOOR SOLID CORE DOOR	2' - 8" 2' - 4"	6' - 8" 6' - 8"			PER OWNER PER OWNER				1			
	205A	SOLID CORE DOOR	2' - 8"	6' - 8"			PER OWNER				4			
[(GENE	RAL NOTES - DO	ORS			GE	NERAL NO	DTES - DOO	R HARDWA	ARE]			
_ 1		NEW EXTERIOR DOOR ASSEMBLIES HERWISE.	S SHALL BE W	OOD UNLES	S NOTED	1.		ITRACTOR SHALL PROV HOWN ON ARCHITECTS I		UIRED BUCK				
2	2. ALL THI	. NEW EXTERIOR DOOR RAILS AND S CK.	STILES SHALL	BE NOT LES	S THAN 1 3/4"	2.		NTRACTOR SHALL PROV CHITECTURAL DRAWING		RS AS				
3		NEW EXTERIOR DOORS TO BE VER			G.	3.	BUILDING REQUIRE	ALL BE CODED AND/OR I	R KEYS ARE TO BE DE	LIVERED TO				
5		FER TO EXTERIOR ELEVATIONS FOR NER TO SELECT INTERIOR DOOR ST						Y TESTED AND/OR TAGG BE COORDINATED WITH						
6		FER TO PLAN DRAWINGS FOR SWING				4.	THE QUANTITIES, T	LL SUBMIT A DETAILED YPES, MANUFACTURER	S, CATALOG NUMBER	S AND				
7		NEW GLAZED DOORS SHALL BE DU		/ITH TEMPER	ED GLASS		HARDWARE LIST S	E VARIOUS ARTICLES OF HALL BE SUBMITTED NO	LATER THAN (30) DAY	S BEFORE THE				
8	,	TH PANELS) UNLESS OTHERWISE N . GLAZING IN HAZARDOUS LOCATION		DENTIFIED F	. Υ Δ		ORDER TO MEET T	R MUST PLACE THE OR HE PROJECT SCHEDULE ALL NOT BE CONSTRUED	. REVIEW OF THE HA	RDWARE LIST				
	PEF	RMANENT LABEL IDENTIFYING IT AS ALL BE INSTALLED IN FIXED AND SLI	SAFETY GLAZ	ING. SAFET	Y GLAZING			DES NOT RELIEVE THE C						
	WIN	SEMBLIES, IN SHOWER AND TUB ENO NDOWS WITH SILL HEIGHT OF 60" OF	R LESS, IN FIXE	ED OR OPER	ABLE PANELS	5.		HARDWARE SHALL BE IN						
	IS V	JACENT TO A DOOR WHERE THE NE VITHIN A 24" ARC OF EITHER VERTIC SITION, OR WHERE THE BOTTOM EX	CAL EDGE OF T	THE DOOR IN	I A CLOSED			CONTAINER; PROPERLY I THE APPROVED HARD\		D IN				
		AN 18" ABOVE THE WALKING SURFAC		OF THE GLA	ZING IS LESS	6.		PPLIED TO METAL DOOR ALL BE SECURED BY MA		E MADE TO				
1	10. PR	DERCUT DOOR FOR MINIMUM CLEAF DVIDE DOOR SCHEDULE SHOP DRAN R ARCHITECT'S APPROVAL.				7.		T HINGES FOR DOORS L FOR EACH 2 1/2 FT.	JP TO 5 FT. HIGH AND	ONE				
1	I1. A O	NE HOUR OCCUPANCY SEPARATION RAGE, DOORS TO BE (1) HOUR RATE		TWEEN THE	HOUSE &	8.		LL FURNISH STANDARD IRED TO PROTECT TRIM LATCH BOLT.						
1		NEW GLAZING SHALL HAVE U-VALL XIMUM AT OWNER'S OPTION, NORTH				9.	CONTRACTOR SHA	LL PROVIDE DUST COVE	ERS AT ALL STRIKE PL	ATES.				
	"LO WIT	W E", WEST AND EAST FACING GLAZ TH OWNER.	ZING SHALL BE	E "LOW E2".	VERIFY TINT	10.	ALIKE AND/OR KEY	IER SHALL PROVIDE GR -DIFFERENT ALL LOCKS DED BY THE TENANT.		,				
		E NFRC THERMAL PERFORMANCE LA AL INSPECTION	ABELS SHALL I	REMAIN ON	DOORS UNTIL	11.	ALL FASTENERS SI	HALL MATCH THE HARD	WARE MATERIAL AND	FINISH.				
1	BE PAI R32 OR	AZING IN EXTERIOR WALLS AND DOC CONSTRUCTED OF MULTIPANE GLA NE MEETING THE REQUIREMENTS O 27.8.2.1. THE EXCEPTION TO SECTIO FIRE -RETARDANT TREATED WOOD Q'D TO COMPLY WITH THIS CHAPTER	AZING WITH A N OF SECTION 24(ON 704A.3.2.3 ST O VEHICLE ACC	MINIMUM ON 06 SAFETY 0 TATES: NON	E TEMPERED GLAZING CRC COMBUSTIBLE	12.	THE PROJECT AND RESPONSIBILITY O OPERATIONAL SYS	RDWARE SCHEDULE IS ESTABLISH A TYPE AND F THE CONTRACTOR TO STEM OF DOOR FINISH H THIN THE PROJECT AREA) STANDARD OF QUAL) FURNISH A COMPLET ARDWARE ITEMS, ENC	ITY. IT IS THE E AND				
1		E DETAILS FOR INSTALLATION DETA				13.		DOOR OPENING HARDW. RE THAN 44" HIGH AND S						
1	l6. FIE	LD VERIFY ALL CONDITIONS FOR PL	ACEMENT, SIZ	ZE, DETAILS.		l.,		JIRING GRASPING OF TH						
1		NTRACTOR TO VERIFY WALL THICKN	NESS & COORI	DINATE JAMI	3 WIDTH	14.	THE PATH OF TRAV	CKING DOORS THAT ARE /EL TO THE COMMERCIA H A SINGLE EFFORT BY I	L SPACES OF THIS PF	ROJECT SHALL				
1	I8. FIE	LD VERIFY ALL DOOR DIMENSION RO TH HEAD, JAMB, SILL & DETAILS.	OUGH OPENIN	IGS. VERIFY	DIMENSIONS		BARS, PUSH-PULL	ACTIVATED BARS, OR O'E WITHOUT REQUIRING	THER HARDWARE DES	SIGNED TO				
1		EXTERIOR DOORS, PROVIDE 36" DEI FERIOR LANDINGS SHALL NOT EXCE C]				15.	EXCEEDING 5 LBS	REQUIRED, SHALL HAVE FOR EXTERIOR DOORS A E-RATED DOORS WHICH	AND INTERIOR DOORS	WITH THE				
2	LO\ NO ELE	NDINGS AT THE REQUIRED EGRESS WER THAN THE TOP OF THE THRESH T DO NOT SWING OVER THE LANDIN EVATION OF 7 3/4" MAXIMUM BELOW	HOLD. LANDIN IG MAY HAVE A	IGS WITH DO A DIFFERENC	ORS THAT DO CE IN	16.	LEADING EDGES R	LL NOT BE GREATER TH EVEALED OR SLOPED A NO SINGLE VERTICAL (TAN ANGLE NOT EXC	EEDING 45				
2		NDINGS AT DOORS OTHER THAN THE RE THAN 7 3/4" MAXIMUM BELOW TH				17.	HAVE A SMOOTH U	F ALL DOORS (EXCEPT A NINTERRUPTED SURFA H A 10" HIGH SMOOTH PA	CE. NARROW FRAME	DOÓRS SHALL				
						18.		AL NOTES AND RESPECT S ON DOORS, FRAMES A		SHEETS FOR				

WINDOW SCHEDULE ROUGH OPENING HEAD PHASE MARK WIDTH HEIGHT MANUFACTURE MATERIAL COUNT HEIGHT CREATED COMMENTS SLOI FLAT SKYLIGHT WINDOW 2' - 0" MAIN HOUSE SLO2 FLAT SKYLIGHT WINDOW 2' - 0" ALUM 2 4' - O" VELUX MAIN HOUSE 1 6 - 8" MAIN HOUSE MOVE (E) WINDOW SEE PLAN WO1 4' - 6" FIXED WINDOW 2 | 6 - 8" | MAIN HOUSE | WO3 SINGLE HUNG WINDOW 3' - O" 4' - O" WD WO4 FIXED WINDOW WD 1 6' - 8" MAIN HOUSE 3' - O" DOUBLE SINGLE HUNG 6' - 8" MAIN HOUSE WINDOW VERTICAL GRAIN DOUGLAS FIR W06 DOUBLE SINGLE HUNG 2' - 6" 6' - 8" MAIN HOUSE WINDOW DOUBLE SINGLE HUNG | <VARIES> | MAIN HOUSE SECURITY PROVISIONS APPLY WINDOW

1 6 - 8" MAIN HOUSE MATCH (E) PROFILE

GENERAL NOTES - WINDOWS

W08 SLIDER WINDOW

PANIC HARDWARE

SOLID CORE WOOD

REMOVABLE MULLION

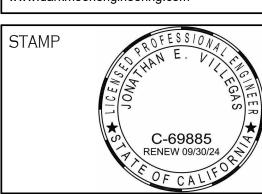
ALL NEW EXTERIOR WINDOW ASSEMBLIES SHALL BE WOOD TO MATCH EXISTING UNLESS NOTED OTHERWISE.

4' - O"

- ALL NEW WINDOWS TO BE VERIFIED PRIOR TO ORDERING
- REFER TO EXTERIOR ELEVATIONS FOR WINDOW AND DOOR STYLE.
- SIZES ARE NOMINAL. ALL OPENINGS SHALL BE FIELD MEASURE AND VERIFIED WITH SHOP DRAWINGS PRIOR TO FABRICATION.
- ALL EGRESS WINDOWS SHALL CONFORM TO CBC 310.4 AND SHALL HAVE NET CLEAR OPERABLE AREA OF 5.7 SQUARE FEET. THE NET MINIMUM CLEAR OPERABLE HEIGHT DIMENSION SHALL BE 24 INCHES. THE NET MINIMUM CLEAR OPERABLE WIDTH DIMENSION SHALL BE 20 INCHES. FINISHED SILL HEIGHT SHALL BE NOT MORE THAN 44 INCHES. WINDOW DIMENSIONS SHOWN ON SCHEDULE SHALL BE COORDINATED WITH THE PARTICULAR MANUFACTURER 'S SIZES TO ASSURE CONFORMANCE.
- ALL GLAZING IN HAZARDOUS LOCATIONS SHALL BE IDENTIFIED BY A PERMANENT LABEL IDENTIFYING IT AS SAFETY GLAZING. SAFETY GLAZING SHALL BE INSTALLED IN FIXED AND SLIDING PANELS OF SLIDING DOOR ASSEMBLIES, IN SHOWER AND TUB ENCLOSURES, IN SHOWER AND TUB WINDOWS WITH SILL HEIGHT OF 60" OR LESS, IN FIXED OR OPERABLE PANELS ADJACENT TO A DOOR WHERE THE NEAREST EXPOSED EDGE OF THE GLAZING IS WITHIN A 24" ARC OF EITHER VERTICAL EDGE OF THE DOOR IN A CLOSED POSITION, OR WHERE THE BOTTOM EXPOSED EDGE OF THE GLAZING IS LESS THAN 18" ABOVE THE WALKING SURFACE.
- ALL NEW GLAZING SHALL HAVE U-VALUE = 0.30 MAX. AND SHGC = 0.23 MAX. AT OWNER'S OPTION, NORTH AND SOUTH FACING GLAZING SHALL BE "LOW E", WEST AND EAST FACING GLAZING SHALL BE "LOW E2". VERIFY TINT WITH
- THE NFRC THERMAL PERFORMANCE LABELS SHALL REMAIN ON WINDOWS UNTIL FINAL INSPECTION.
- GLAZING IN EXTERIOR WALLS AND WINDOWS IN HIGH FIRE HAZARD AREA SHALL BE CONSTRUCTED OF MULTIPANE GLAZING WITH A MINIMUM ONE TEMPERED PANE MEETING THE REQUIREMENTS OF SECTION 2406 SAFETY GLAZING CRC R327.8.2.1. THE EXCEPTION TO SECTION 704A.3.2.3 STATES: NONCOMBUSTIBLE OR FIRE -RETARDANT TREATED WOOD VEHICLE ACCESS DOORS ARE NOT REQ'D TO COMPLY WITH THIS CHAPTER
- SEE DETAILS FOR INSTALLATION DETAILS.
- CONTRACTOR TO VERIFY WALL THICKNESS & COORDINATE JAMB WIDTH ACCORDINGLY.
- 12. FIELD VERIFY ALL WINDOW DIMENSION ROUGH OPENINGS. VERIFY DIMENSIONS WITH HEAD, JAMB, SILL & DETAILS.
- 13. PROVIDE RETAINING SCREEN FOR ALL NEW SKYLIGHTS [§R308.6.3 CRC]



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No.	Descript.	Date		

PROJECT NUMBER: 2022.019.00 07/16/2024





EXISTING 3D VIEW 1

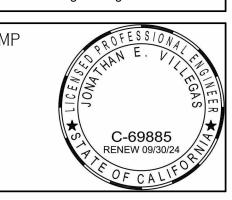








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